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# Lot 101 DP1267563 SOMME AVENUE EDMONDSON PARK STORMWATER DRAINAGE DESIGN



LOCALITY PLAN NOT TO SCALE COPYRIGHT OF NEARMAP

PREPARED BY



S&G CONSULTANTS PTY LTD SUITE 311, LEVEL 3 480 PACIFIC HIGHWAY ST. LEONARDS, N.S.W. 2065 T: +61 2 8883 4239

Email: office@sgce.com.au Web: www.sgce.com.au

ARCHITECT

stanisic architects

DRAWING INDEX									
SHEET No.	DWG. No.	DRAWING TITLE	REV.						
01	S01-SW100	COVER SHEET & DRAWING INDEX	А						
02	S01-SW201	EROSION & SEDIMENT CONTROL PLAN	Α						
03	S01-SW202	EROSION & SEDIMENT CONTROL DETAILS	Α						
04	S01-SW301	STORMWATER DRAINAGE DESIGN BASEMENT 02 PLAN BUILDING A + B	А						
05	S01-SW302	STORMWATER DRAINAGE DESIGN LOWER GROUND FLOOR BUILDING A + B	А						
06	S01-SW303	STORMWATER DRAINAGE DESIGN GROUND FLOOR PLAN BUILDING A + B	Α						
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11	S01-SW401	STORMWATER DRAINAGE DESIGN DETAILS SHEET 01 OF 02	A						
12	S01-SW402	STORMWATER DRAINAGE DESIGN DETAILS SHEET 02 OF 02	A						
13	S01-SW501	STORMWATER GRADING DESIGN MUSIC CATCHMENT PLAN & DETAILS	A						
14	S01-SW502	STORMWATER GRADING DESIGN OSD CATCHMENT PLAN & DETAILS	Α						

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CROATIA 88 DEVELOPMENT PTY LTD






20240006 Project No.


Drawing No. S01-SW100

Revision No. A

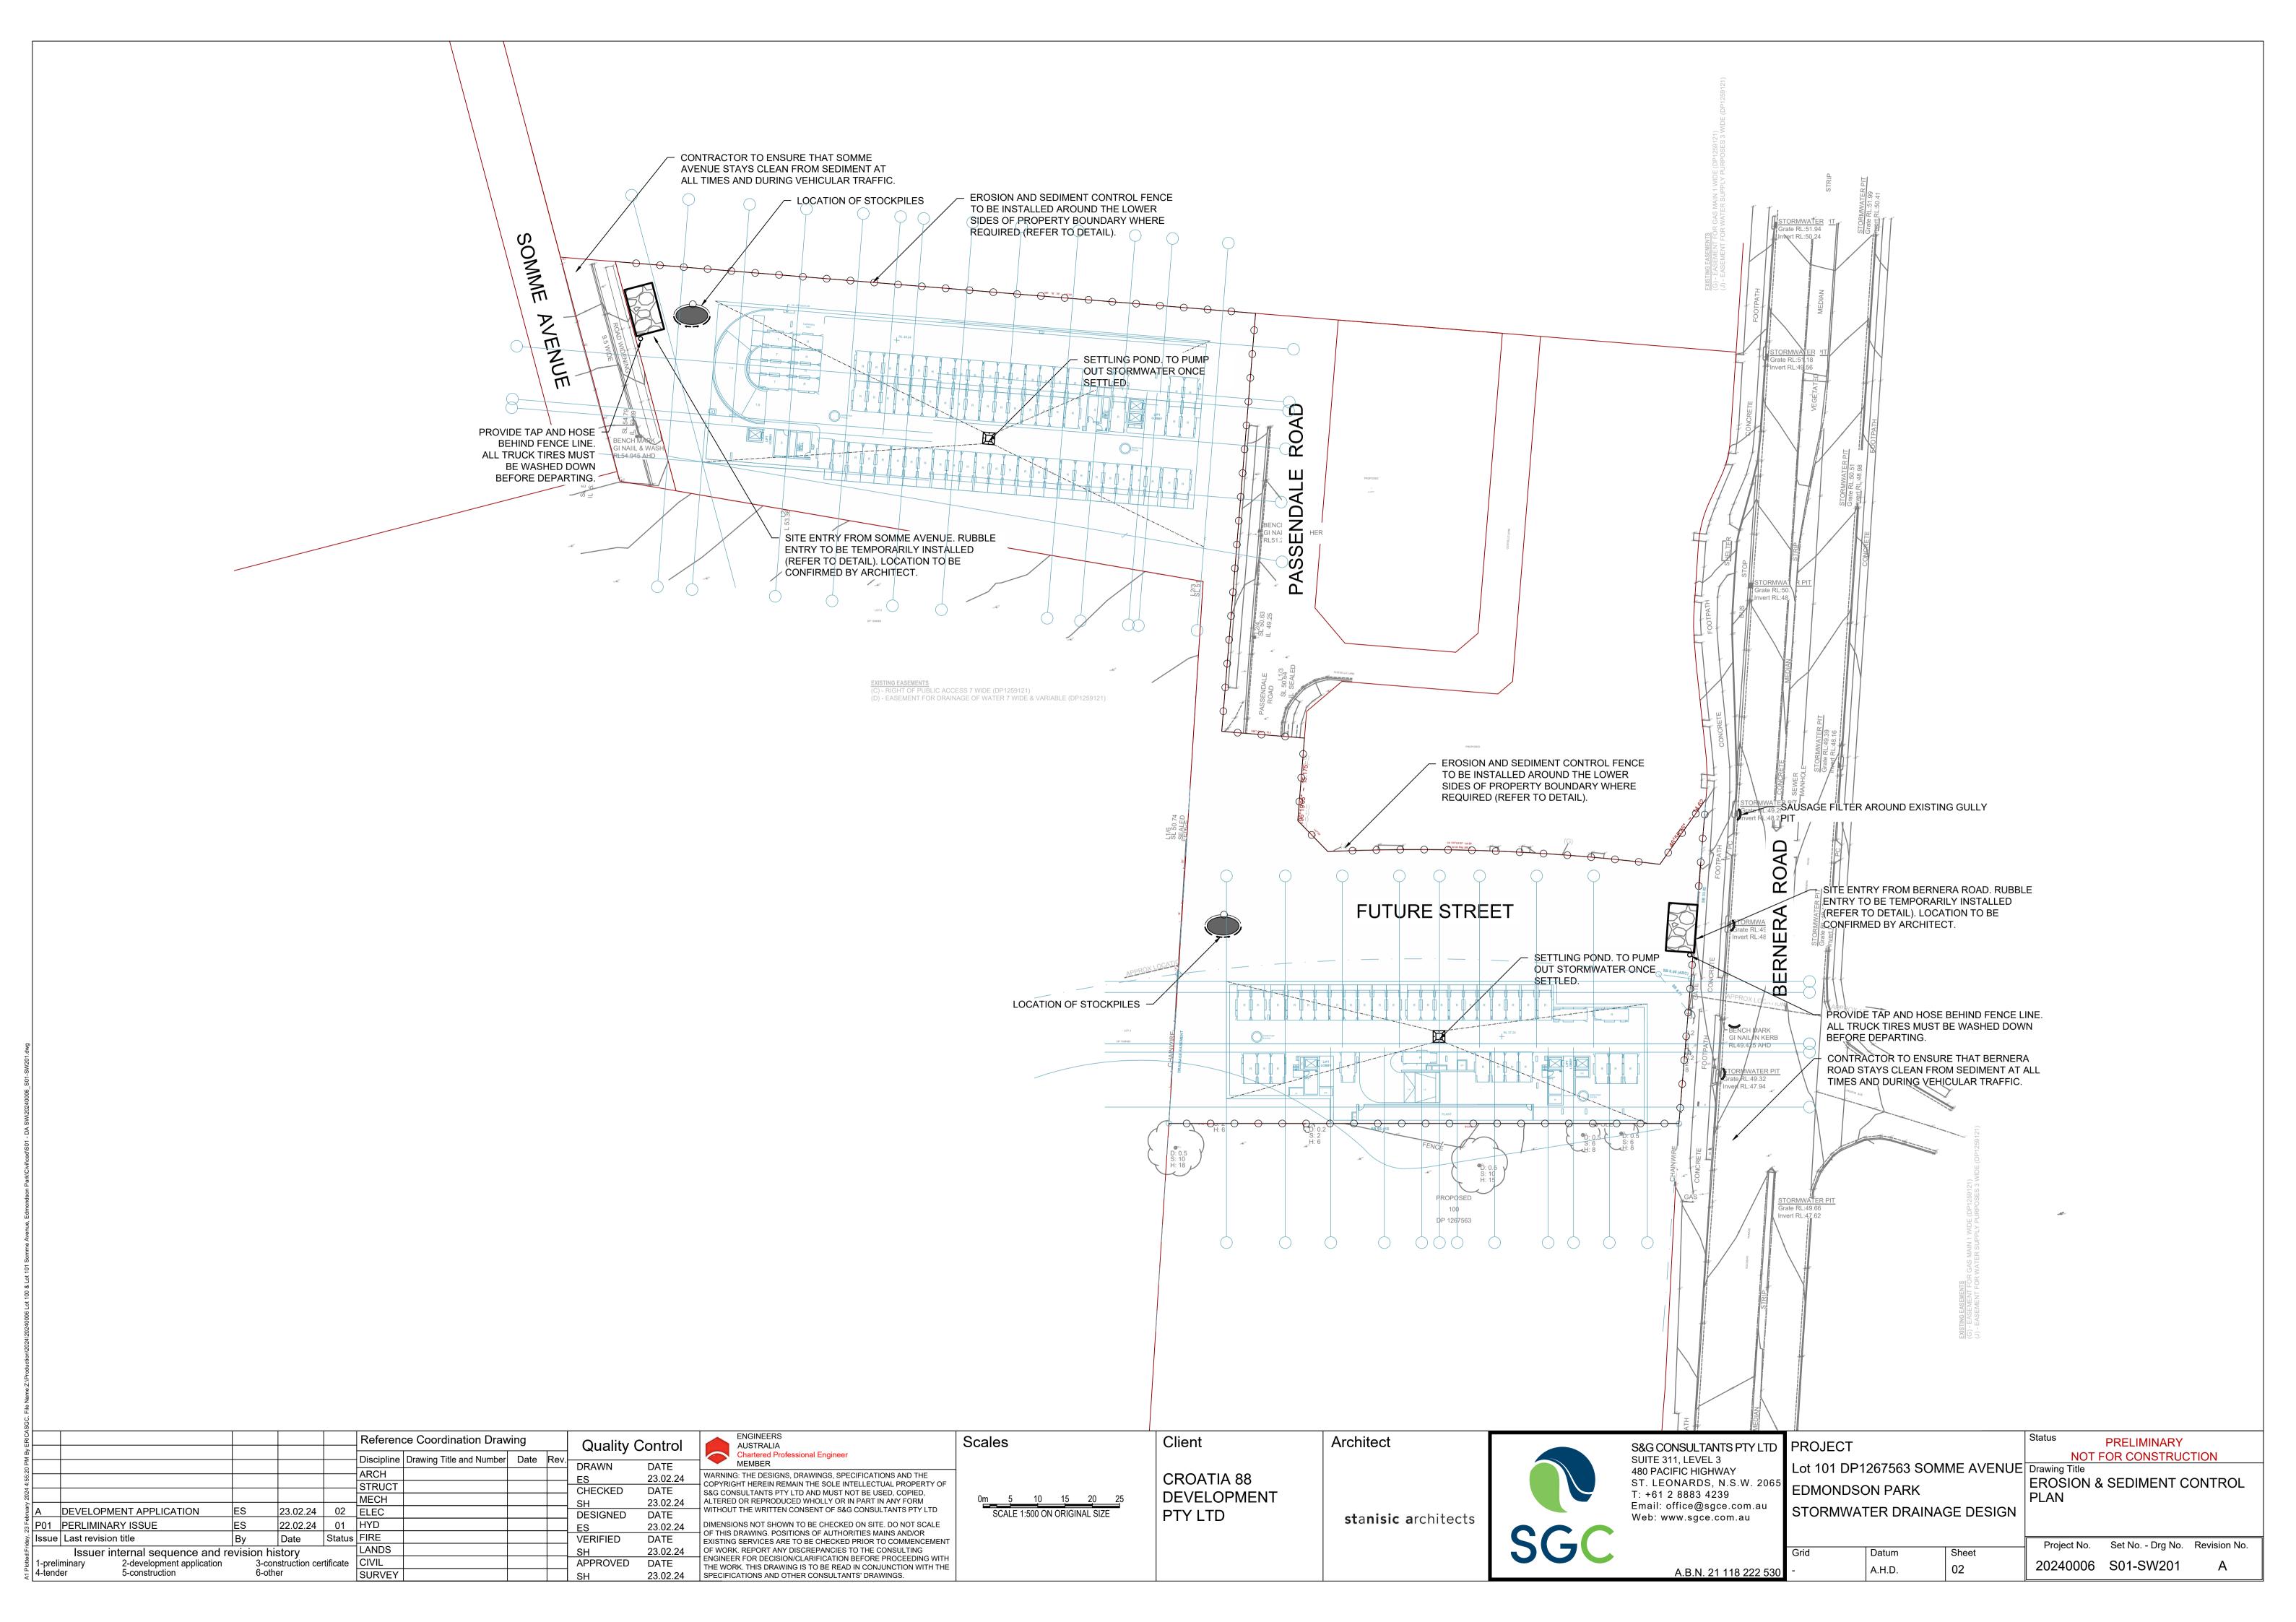

#### **EROSION & SEDIMENTATION CONTROL NOTES**


- 1. CONTRACTOR SHALL PROVIDE SEDIMENT FENCING MATERIAL DURING CONSTRUCTION TO THE LOW SIDE OF THE WORKS. TIE SEDIMENT FENCING MATERIAL TO CYCLONE WIRE SECURITY FENCE. SEDIMENT CONTROL FABRIC SHALL BE AN APPROVED MATERIAL (EG. HUMES PROPEX SILT STOP) STANDING 300mm ABOVE GROUND & EXTENDING 150mm BELOW GROÚND.
- 2. EXISTING DRAINS LOCATED WITHIN THE SITE SHALL ALSO BE ISOLATED BY SEDIMENT FENCING MATERIAL.
- 3. NO PARKING OR STOCKPILING OF MATERIALS IS PERMITTED ON THE LOWER SIDE OF THE SEDIMENT FENCE.
- 4. GRASS VERGES SHALL BE MAINTAINED AS MUCH AS PRACTICAL TO PROVIDE A BUFFER ZONE TO THE CONSTRUCTION SITE.
- 5. CONSTRUCTION ENTRY/EXIT SHALL BE VIA THE LOCATION NOTED ON THE DRAWING. CONTRACTOR SHALL ENSURE ALL DROPPABLE SOIL & SEDIMENT IS REMOVED PRIOR TO CONSTRUCTION TRAFFIC EXITING SITE. CONTRACTOR SHALL ENSURE ALL CONSTRUCTION TRAFFIC ENTERING & LEAVING THE SITE DO SO IN A FORWARD DIRECTION.

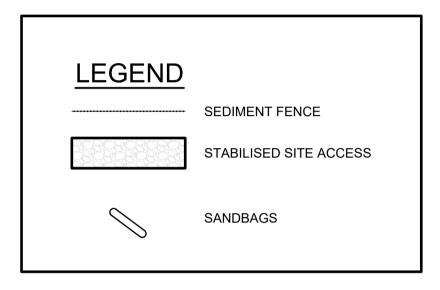

HOUSING "MANAGING URBAN

SOILS & CONSTRUCTION".

STORMWATER

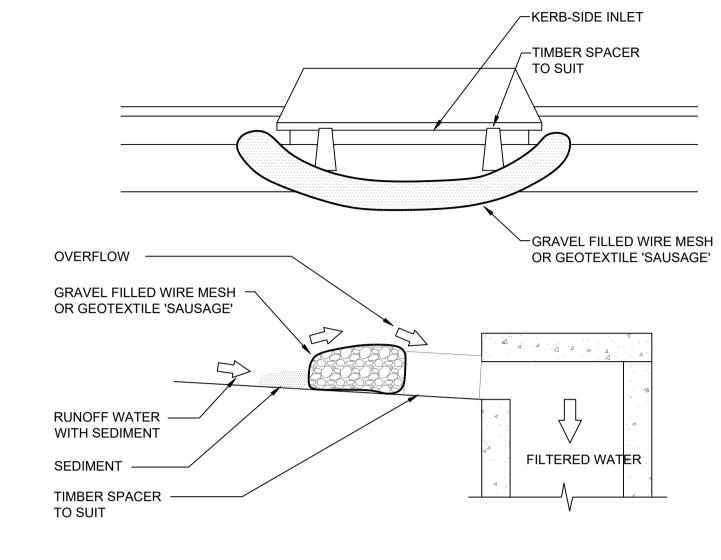

#### GRAVEL INLET FILTER (SAUSAGE) NOT TO SCALE

#### **CONSTRUCTION NOTES**

FABRICATE A SLEEVE MADE FROM GEOTEXTILE OR WIRE MESH LONGER THAT THE LENGTH OF THE INLET PIT

FILL THE SLEEVE WITH 25mm TO 50mm GRAVEL

FORM AN ELLIPTICAL CROSS-SECTION OF THE KERB INLET LEAVING A 100mm GAP AT THE TOP TO ACT AS AN EMERGENCY SPILLWAY

MAINTAIN THE OPENING WITH SPACER BLOCKS

FORM A SEAL WITH THE KERBING AND PREVENT SEDIMENT BYPASSING THE FILTER

FIT TO ALL KERB INLETS AT SAG POINTS


#### **GENERAL NOTES**

- 1. THIS PLAN IS A CONCEPT PLAN ONLY FOR STORMWATER DISPOSAL & EROSION CONTROL. IT IS NOT SUITABLE FOR CONSTRUCTION. THIS PLAN SHOULD BE ADAPTED BY THE BUILDER DURING DEMOLITION, EXCAVATION & CONSTRUCTION PHASES TO ENSURE ADEQUATE PERFORMANCE.
- 2. ALL DRAINAGE LAYOUT & DETAILS ARE DIAGRAMMATIC & INDICATIVE ONLY. ACTUAL LOCATION, SIZES, LEVELS & GRADES MAY ALTER WHEN DETAIL DESIGN WORKS ARE DOCUMENTED.


#### **CLAY SOILS**

A SYSTEM SHALL BE INSTALLED TO EITHER:

- 1. TRANSPORT STORMWATER RUNOFF WITH SUSPENDED SOLIDS FROM SITE VIA PUMP TRUCKS.
- 2. TREAT THE STORMWATER RUNOFF WITH SUSPENDED SOLIDS SO THE DISCHARGE WATER QUALITY TO COUNCIL STORMWATER DRAINAGE SYSTEM HAS A MAXIMUM CONCENTRATION OF SUSPENDED SOLIDS THAT DOES NOT EXCEED 50 MILLIGRAMS PER LITRE IN ACCORDANCE WITH THE PROTECTION OF THE ENVIRONMENT OPERATION ACT (POEO 1997) AND SHALL BE APPROVED BY LOCAL COUNCIL

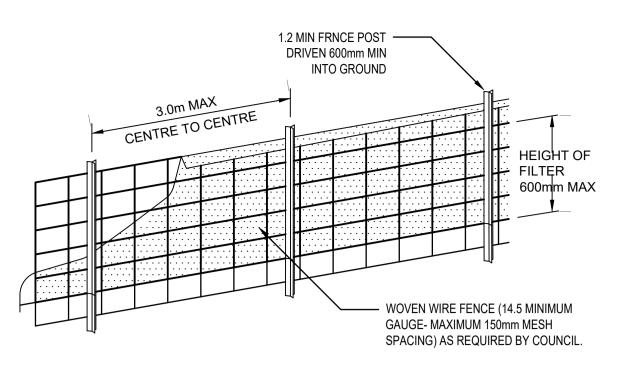



#### DIAGRAMMATIC VIEW

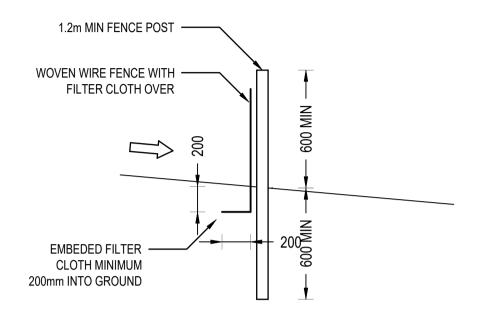

TYPICAL SECTION



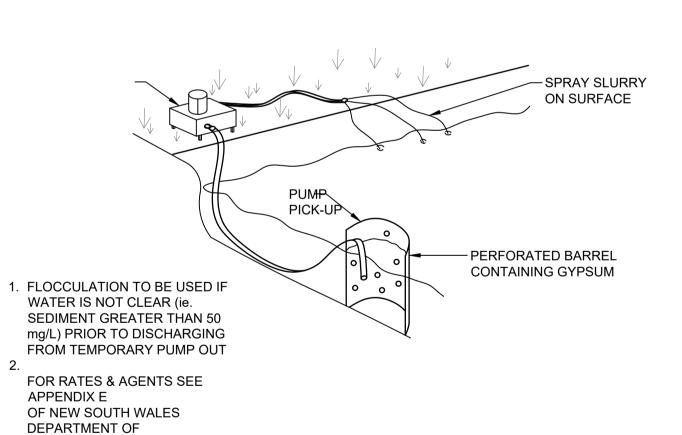


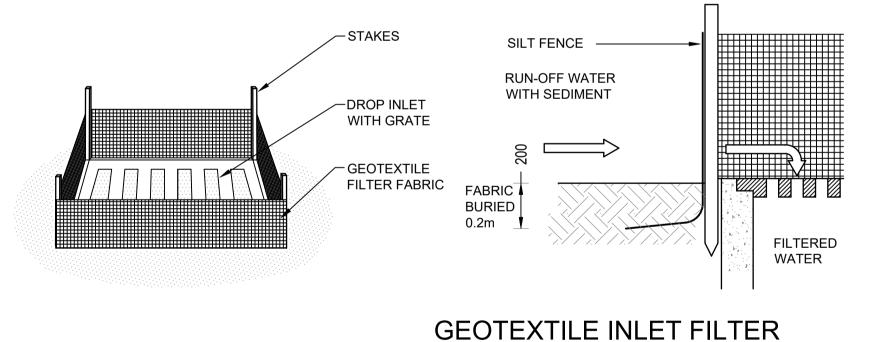


NOT TO SCALE

#### GEOTEXTILE INLET FILTER

GEOTEXTILE INLET FILTER IS PLACED IN EVERY PIT WITHIN THE SITE TO ENSURE THE RUNOFF WATER DURING CONSTUCTION NOT ENTER THE PITS.

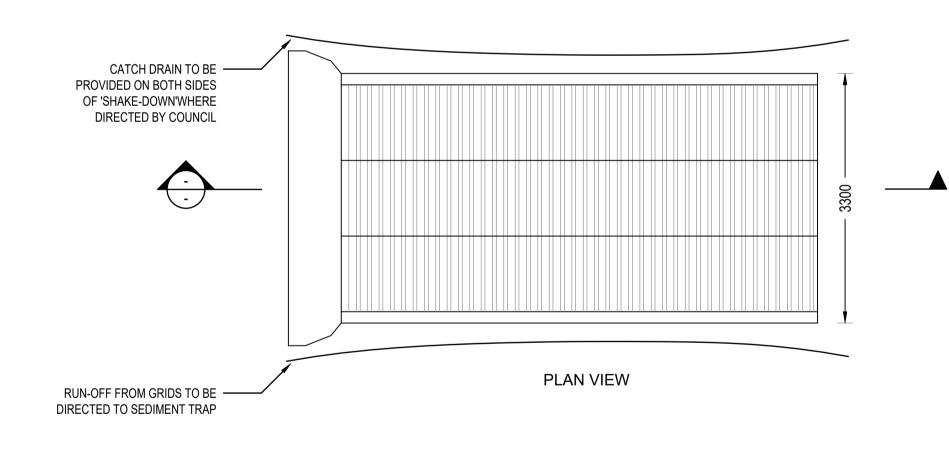


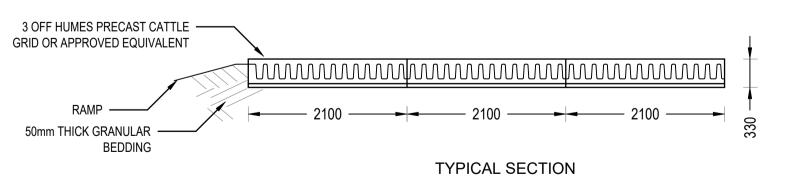


'CATTLE GRID' ALTERNATIVE TEMPORARY CONSTRUCTION EXIT NOT TO SCALE


Discipline   Drawing Title and Number   Date   Rev.   DRAWN	23.02.24 ALTERED OR REPRODUCED WHOLLY OR IN PART IN ANY FORM WITHOUT THE WRITTEN CONSENT OF S&G CONSULTANTS PTY LTD	Scales  CROATIA 88 DEVELOPMENT PTY LTD	Architect  stanisic architects	S&G CONSULTANTS PTY LTD SUITE 311, LEVEL 3 480 PACIFIC HIGHWAY ST. LEONARDS, N.S.W. 2065 T: +61 2 8883 4239 Email: office@sgce.com.au Web: www.sgce.com.au Web: www.sgce.com.au
P01 PERLIMINARY ISSUE ES 22.02.24 01 HYD ES Issue Last revision title By Date Status FIRE VERIFIE VERIFIE SH	DIMENSIONS NOT SHOWN TO BE CHECKED ON SITE. DO NOT SCALE OF THIS DRAWING. POSITIONS OF AUTHORITIES MAINS AND/OR EXISTING SERVICES ARE TO BE CHECKED PRIOR TO COMMENCEMENT OF WORK. REPORT ANY DISCREPANCIES TO THE CONSULTING		Stanisic architects  SG(	Project No.   Set No Drg No.   Revision No.




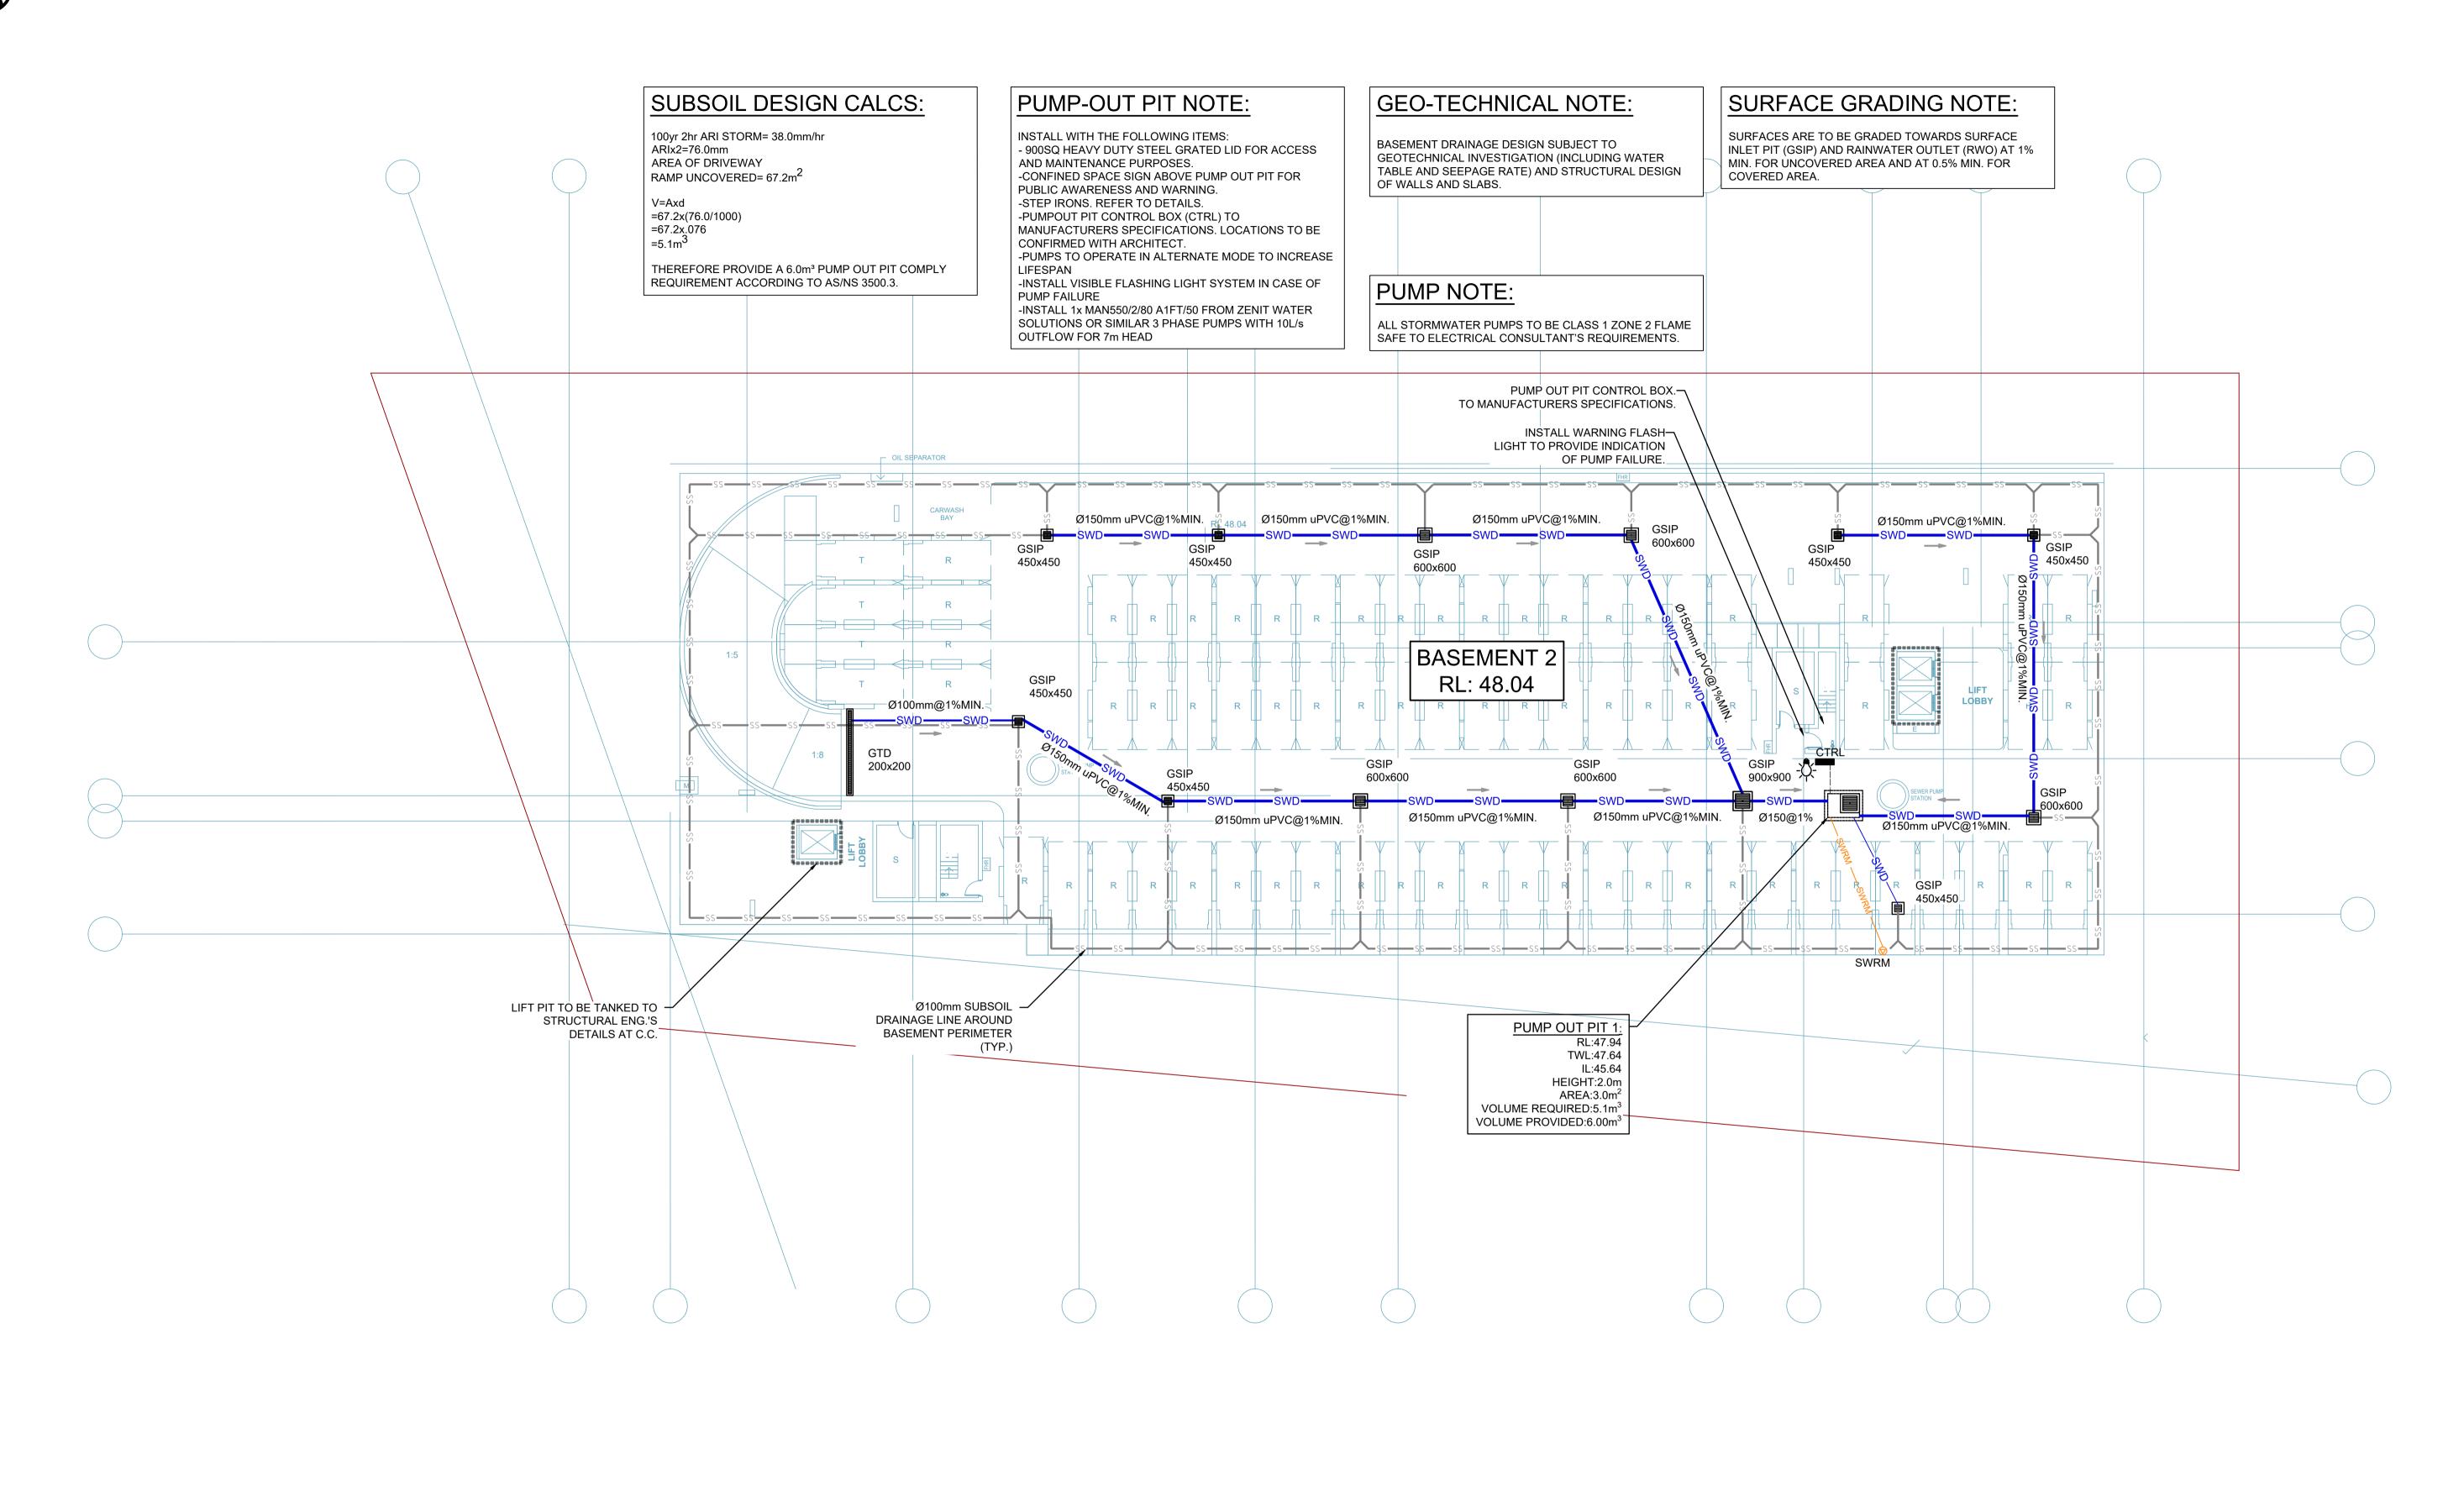



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Disci ARC STRI MEC	ine         Drawing Title and Number         Date         Rev.         DRAWN         DATE           ES         23.02.24           CT         CHECKED         DATE           SH         23.02.24	MEMBER  WARNING: THE DESIGNS, DRAWINGS, SPECIFICATIONS AND THE COPYRIGHT HEREIN REMAIN THE SOLE INTELLECTUAL PROPERTY OF S&G CONSULTANTS PTY LTD AND MUST NOT BE USED, COPIED, ALTERED OR REPRODUCED WHOLLY OR IN PART IN ANY FORM	0 <u>m 2 4 6 8 1</u> 0	CROATIA 88 DEVELOPMENT			ST. LEONARDS, N.S.W. 2065 T: +61 2 8883 4239	EDMONDSON PARK	STORMWATER DRAINAGE DESIGN BASEMENT 02 PLAN
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Issuer internal sequence and revision history 1-preliminary 4-tender 2-development application 5-construction 3-construction certificate 6-other 3-tatus   Title   By   Date   Status   Title   Date   Date   Status   Title   Date   Dat	SH 23.02.24  APPROVED DATE	EXISTING SERVICES ARE TO BE CHECKED PRIOR TO COMMENCEMENT OF WORK. REPORT ANY DISCREPANCIES TO THE CONSULTING ENGINEER FOR DECISION/CLARIFICATION BEFORE PROCEEDING WITH THE WORK. THIS DRAWING IS TO BE READ IN CONJUNCTION WITH THE SPECIFICATIONS AND OTHER CONSULTANTS' DRAWINGS.				<b>56</b> C	A.B.N. 21 118 222 530	Grid Datum Sheet - A.H.D. 04	Project No. Set No Drg No. Revision No. 20240006 S01-SW301 A

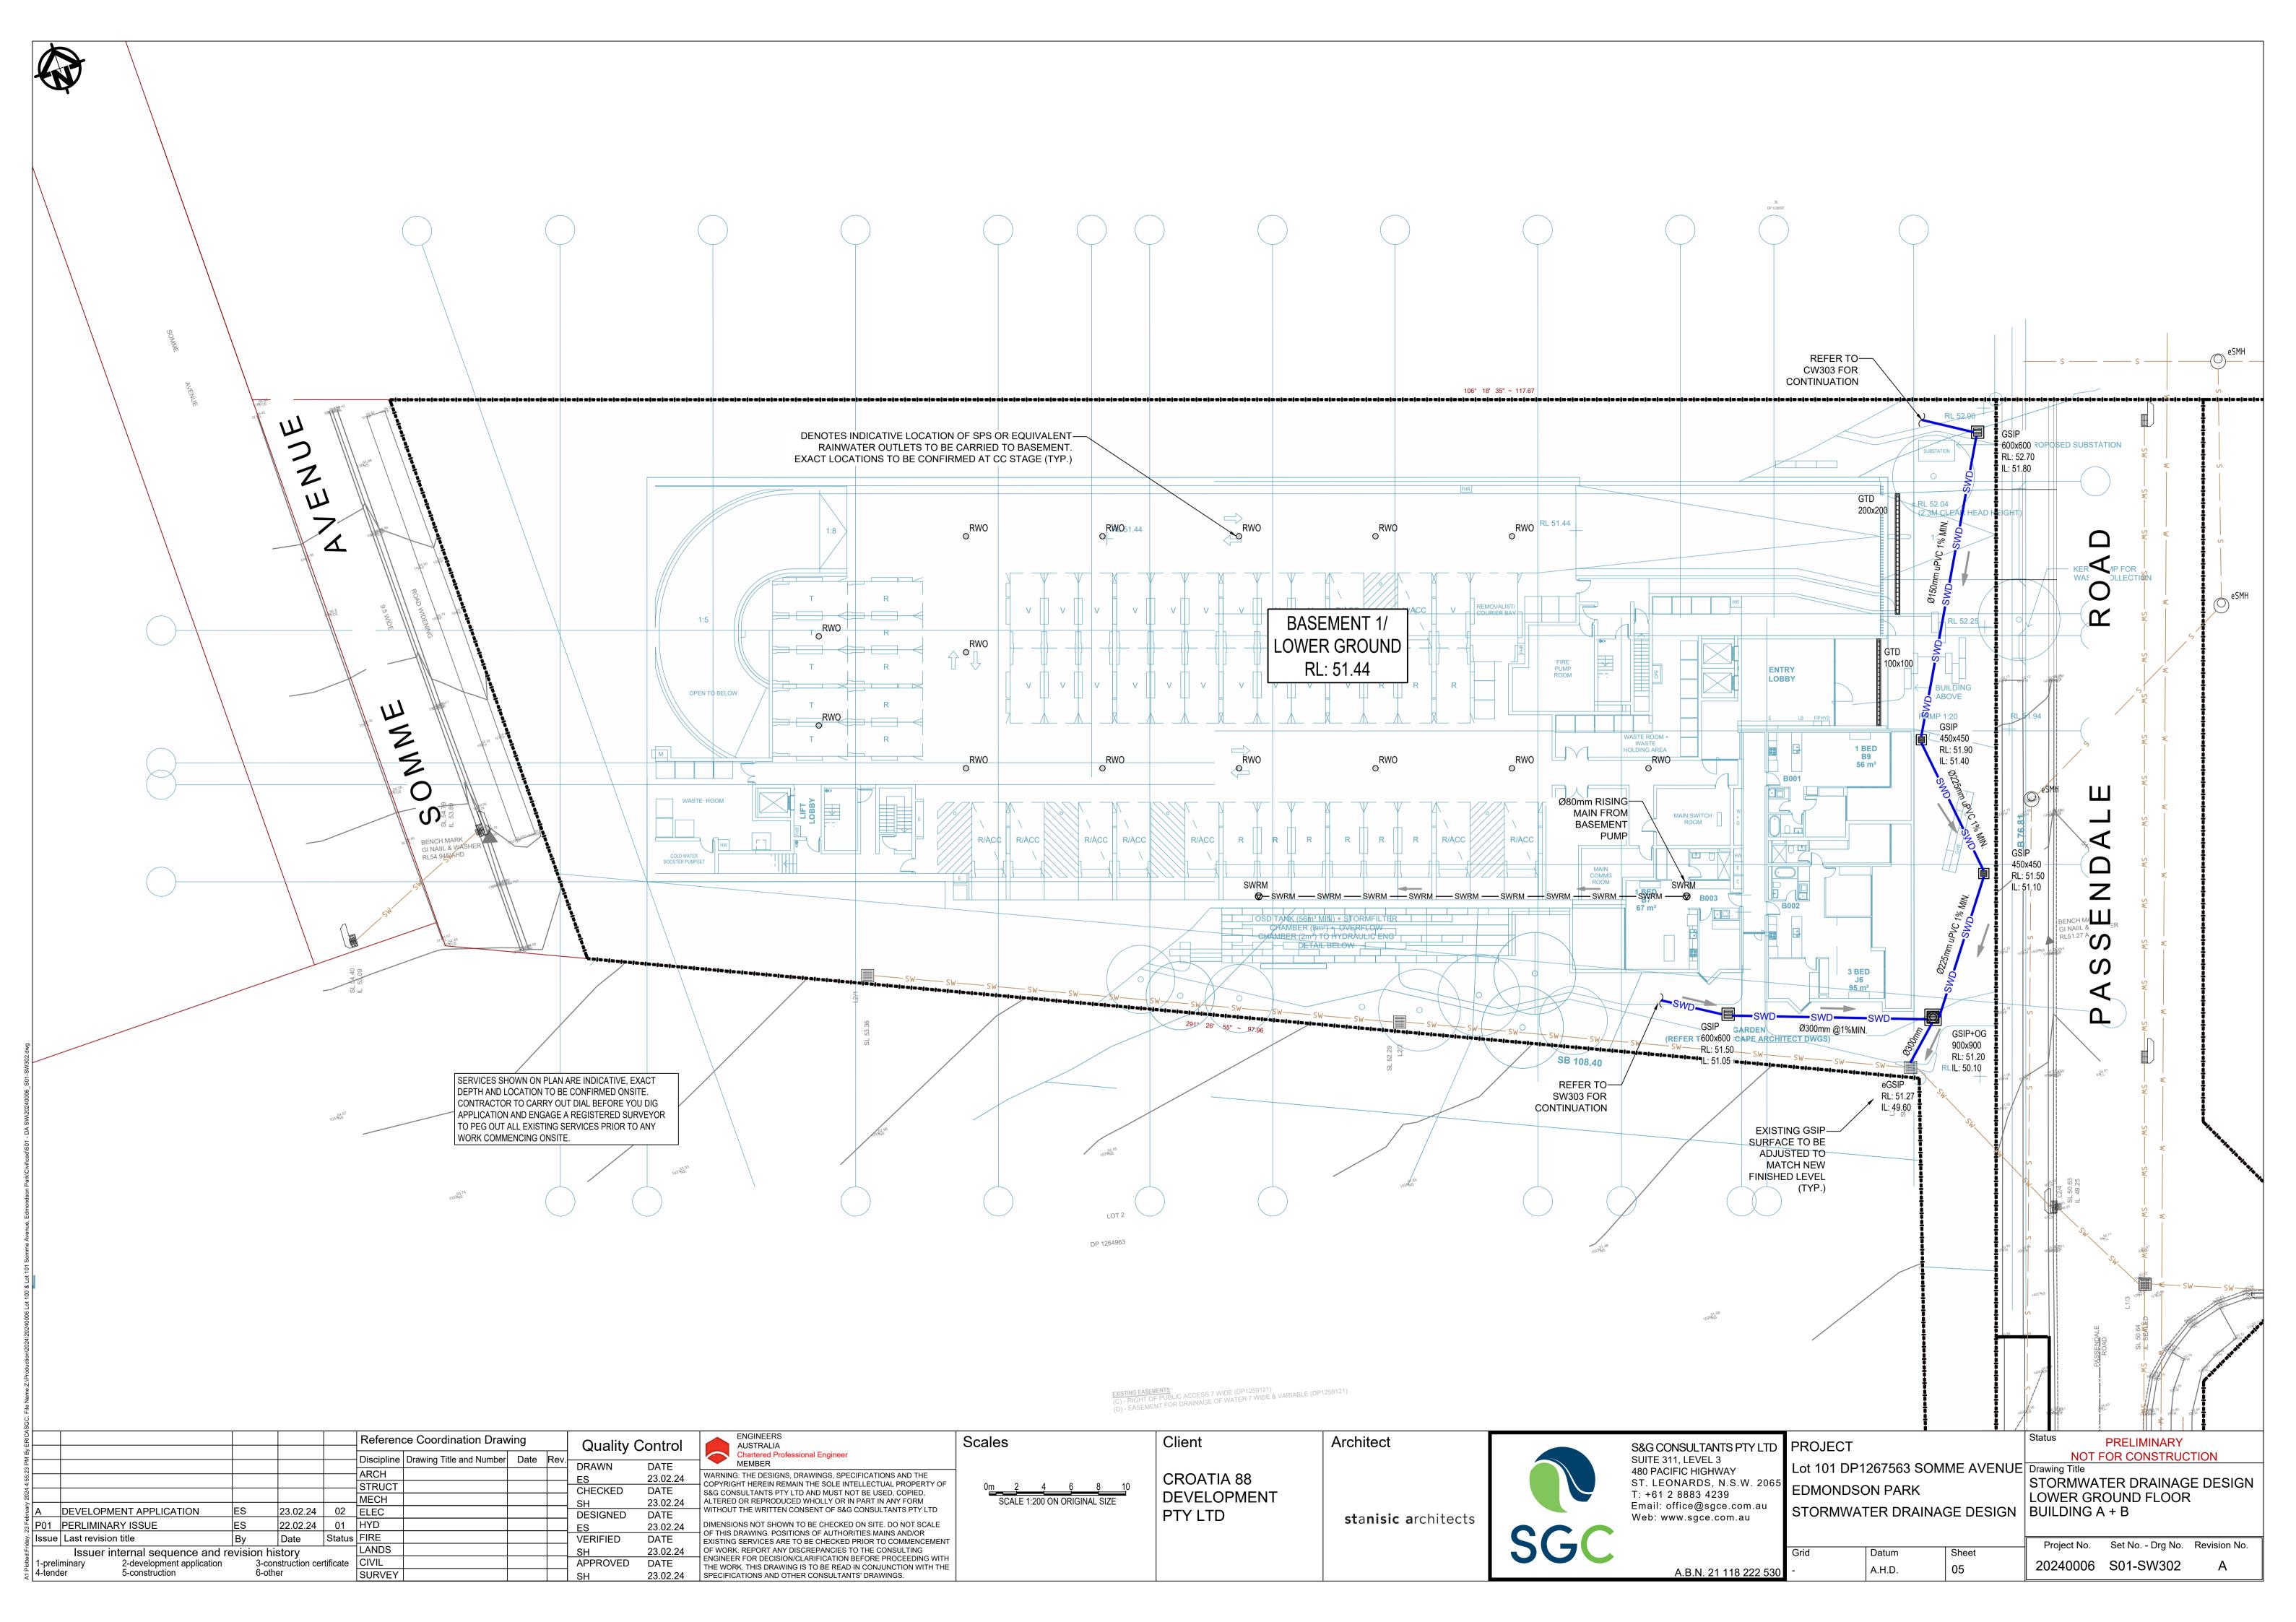


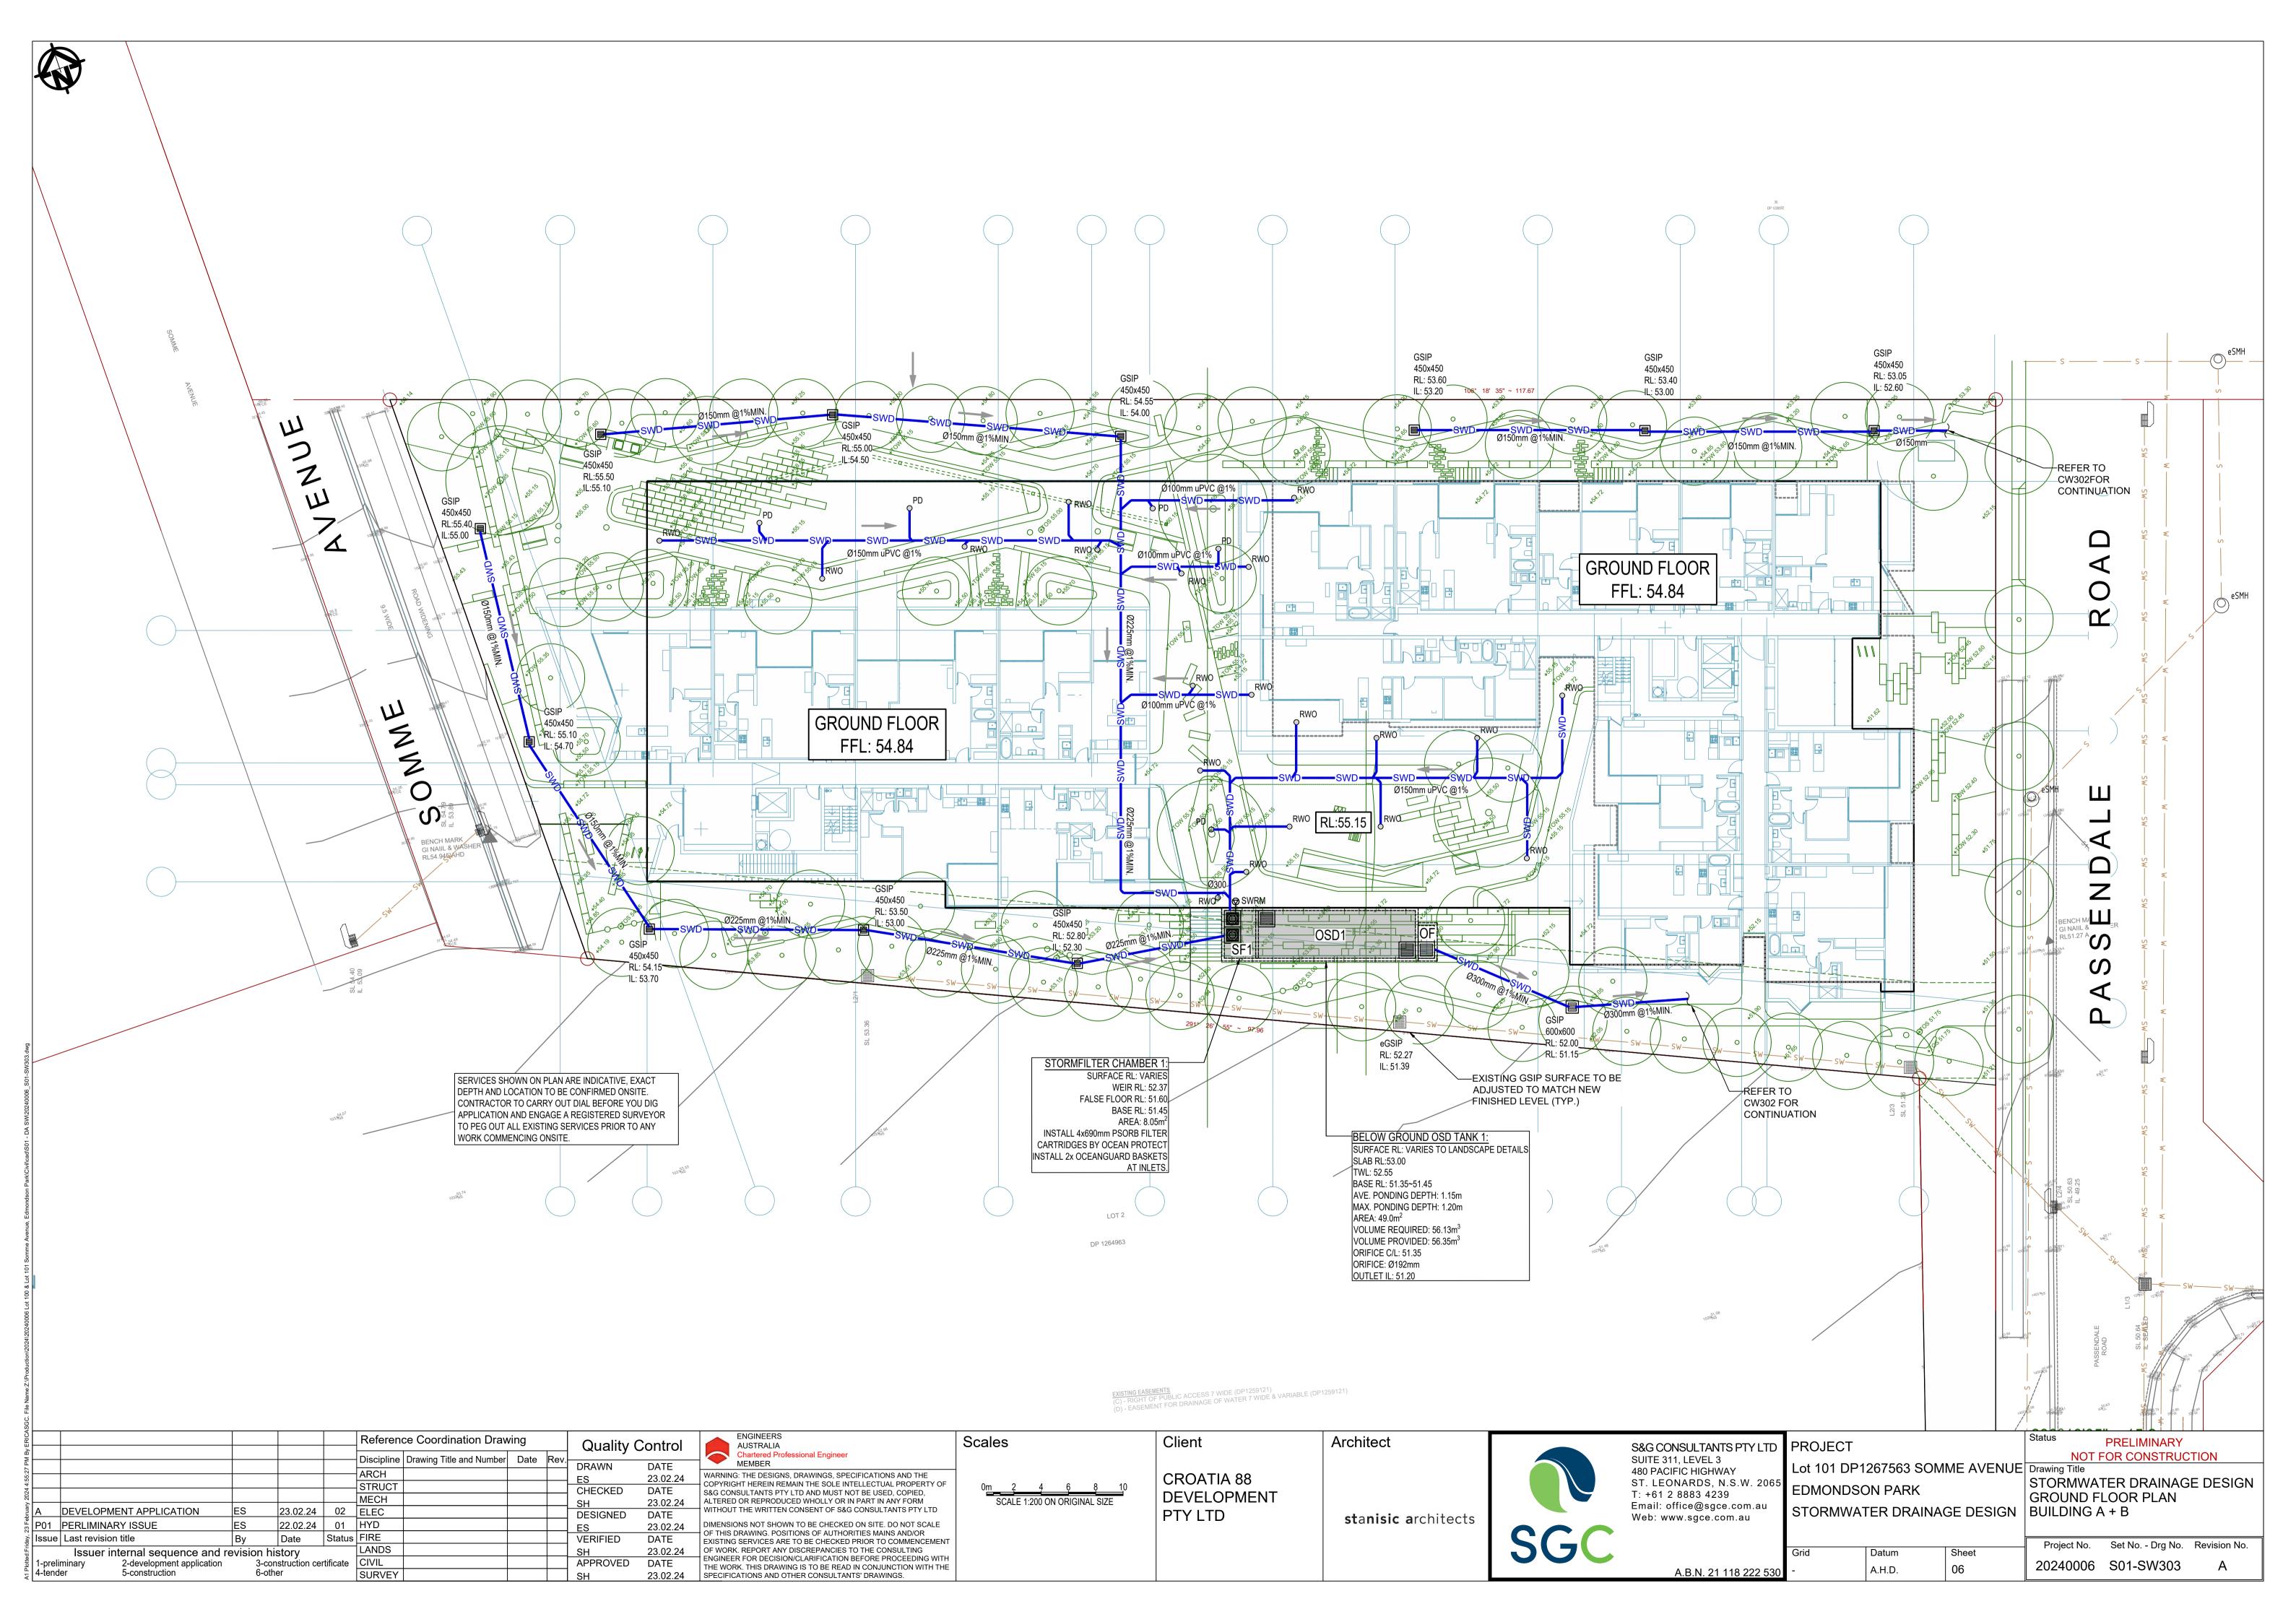


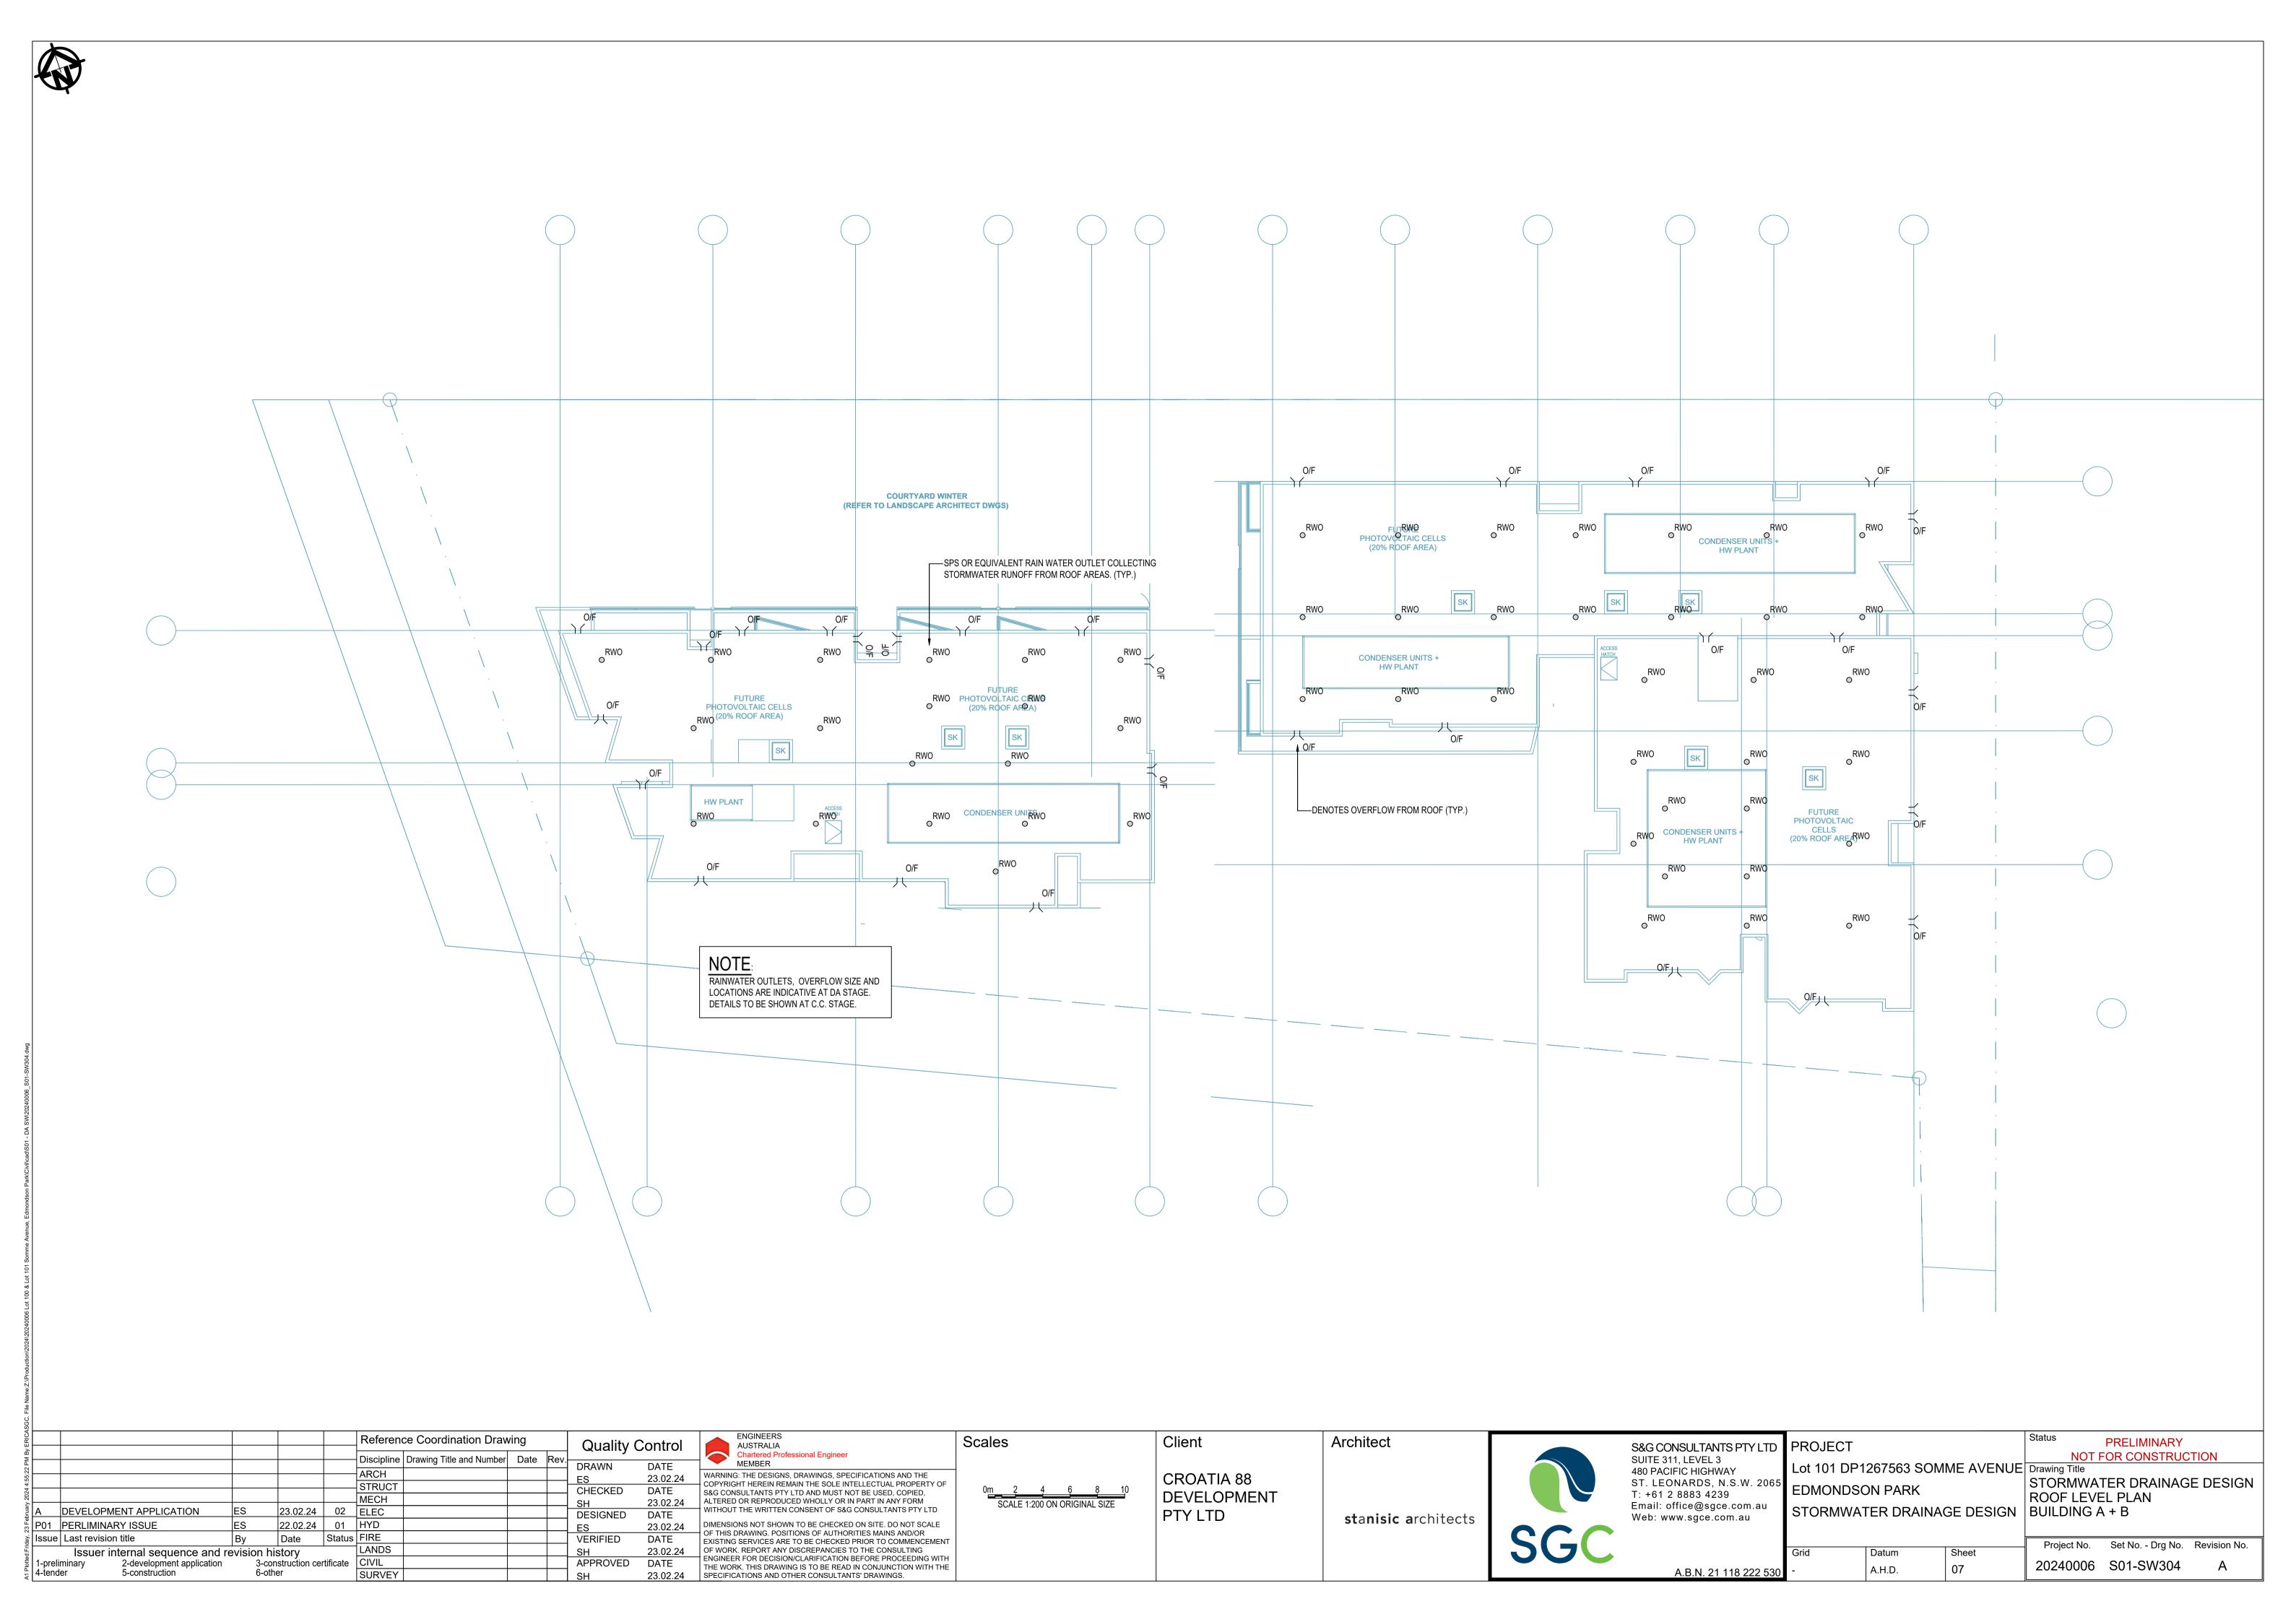

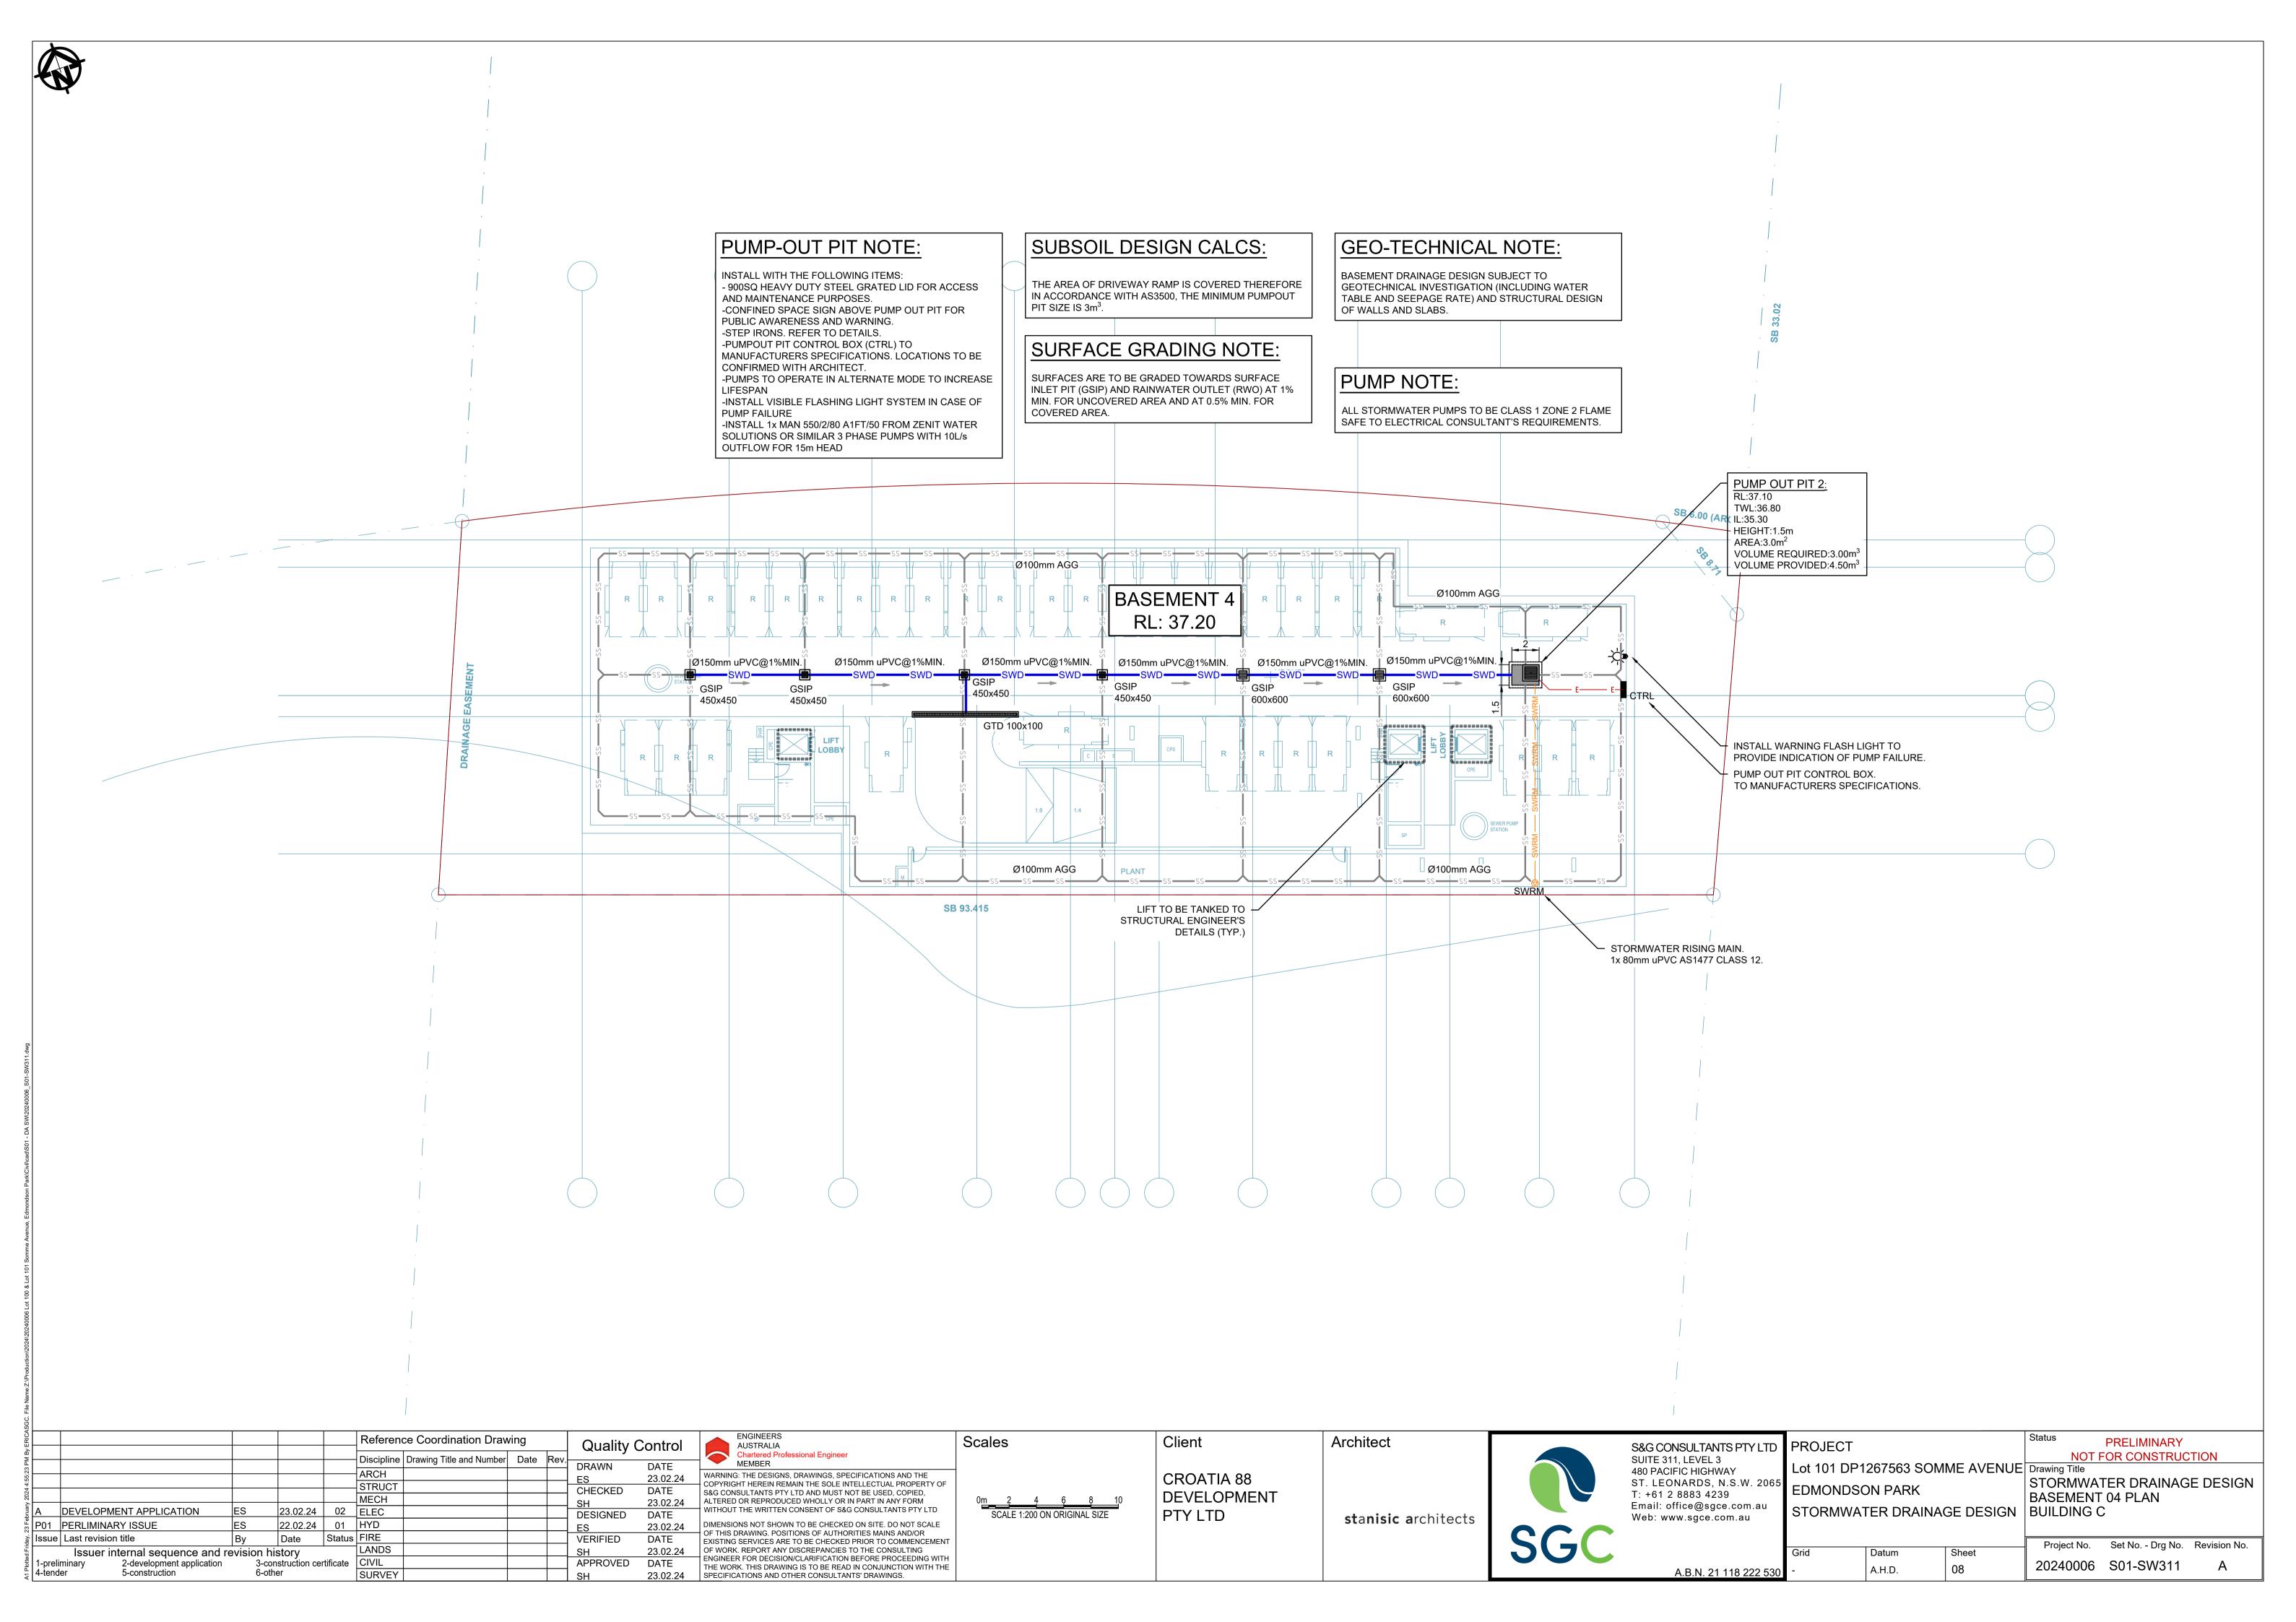


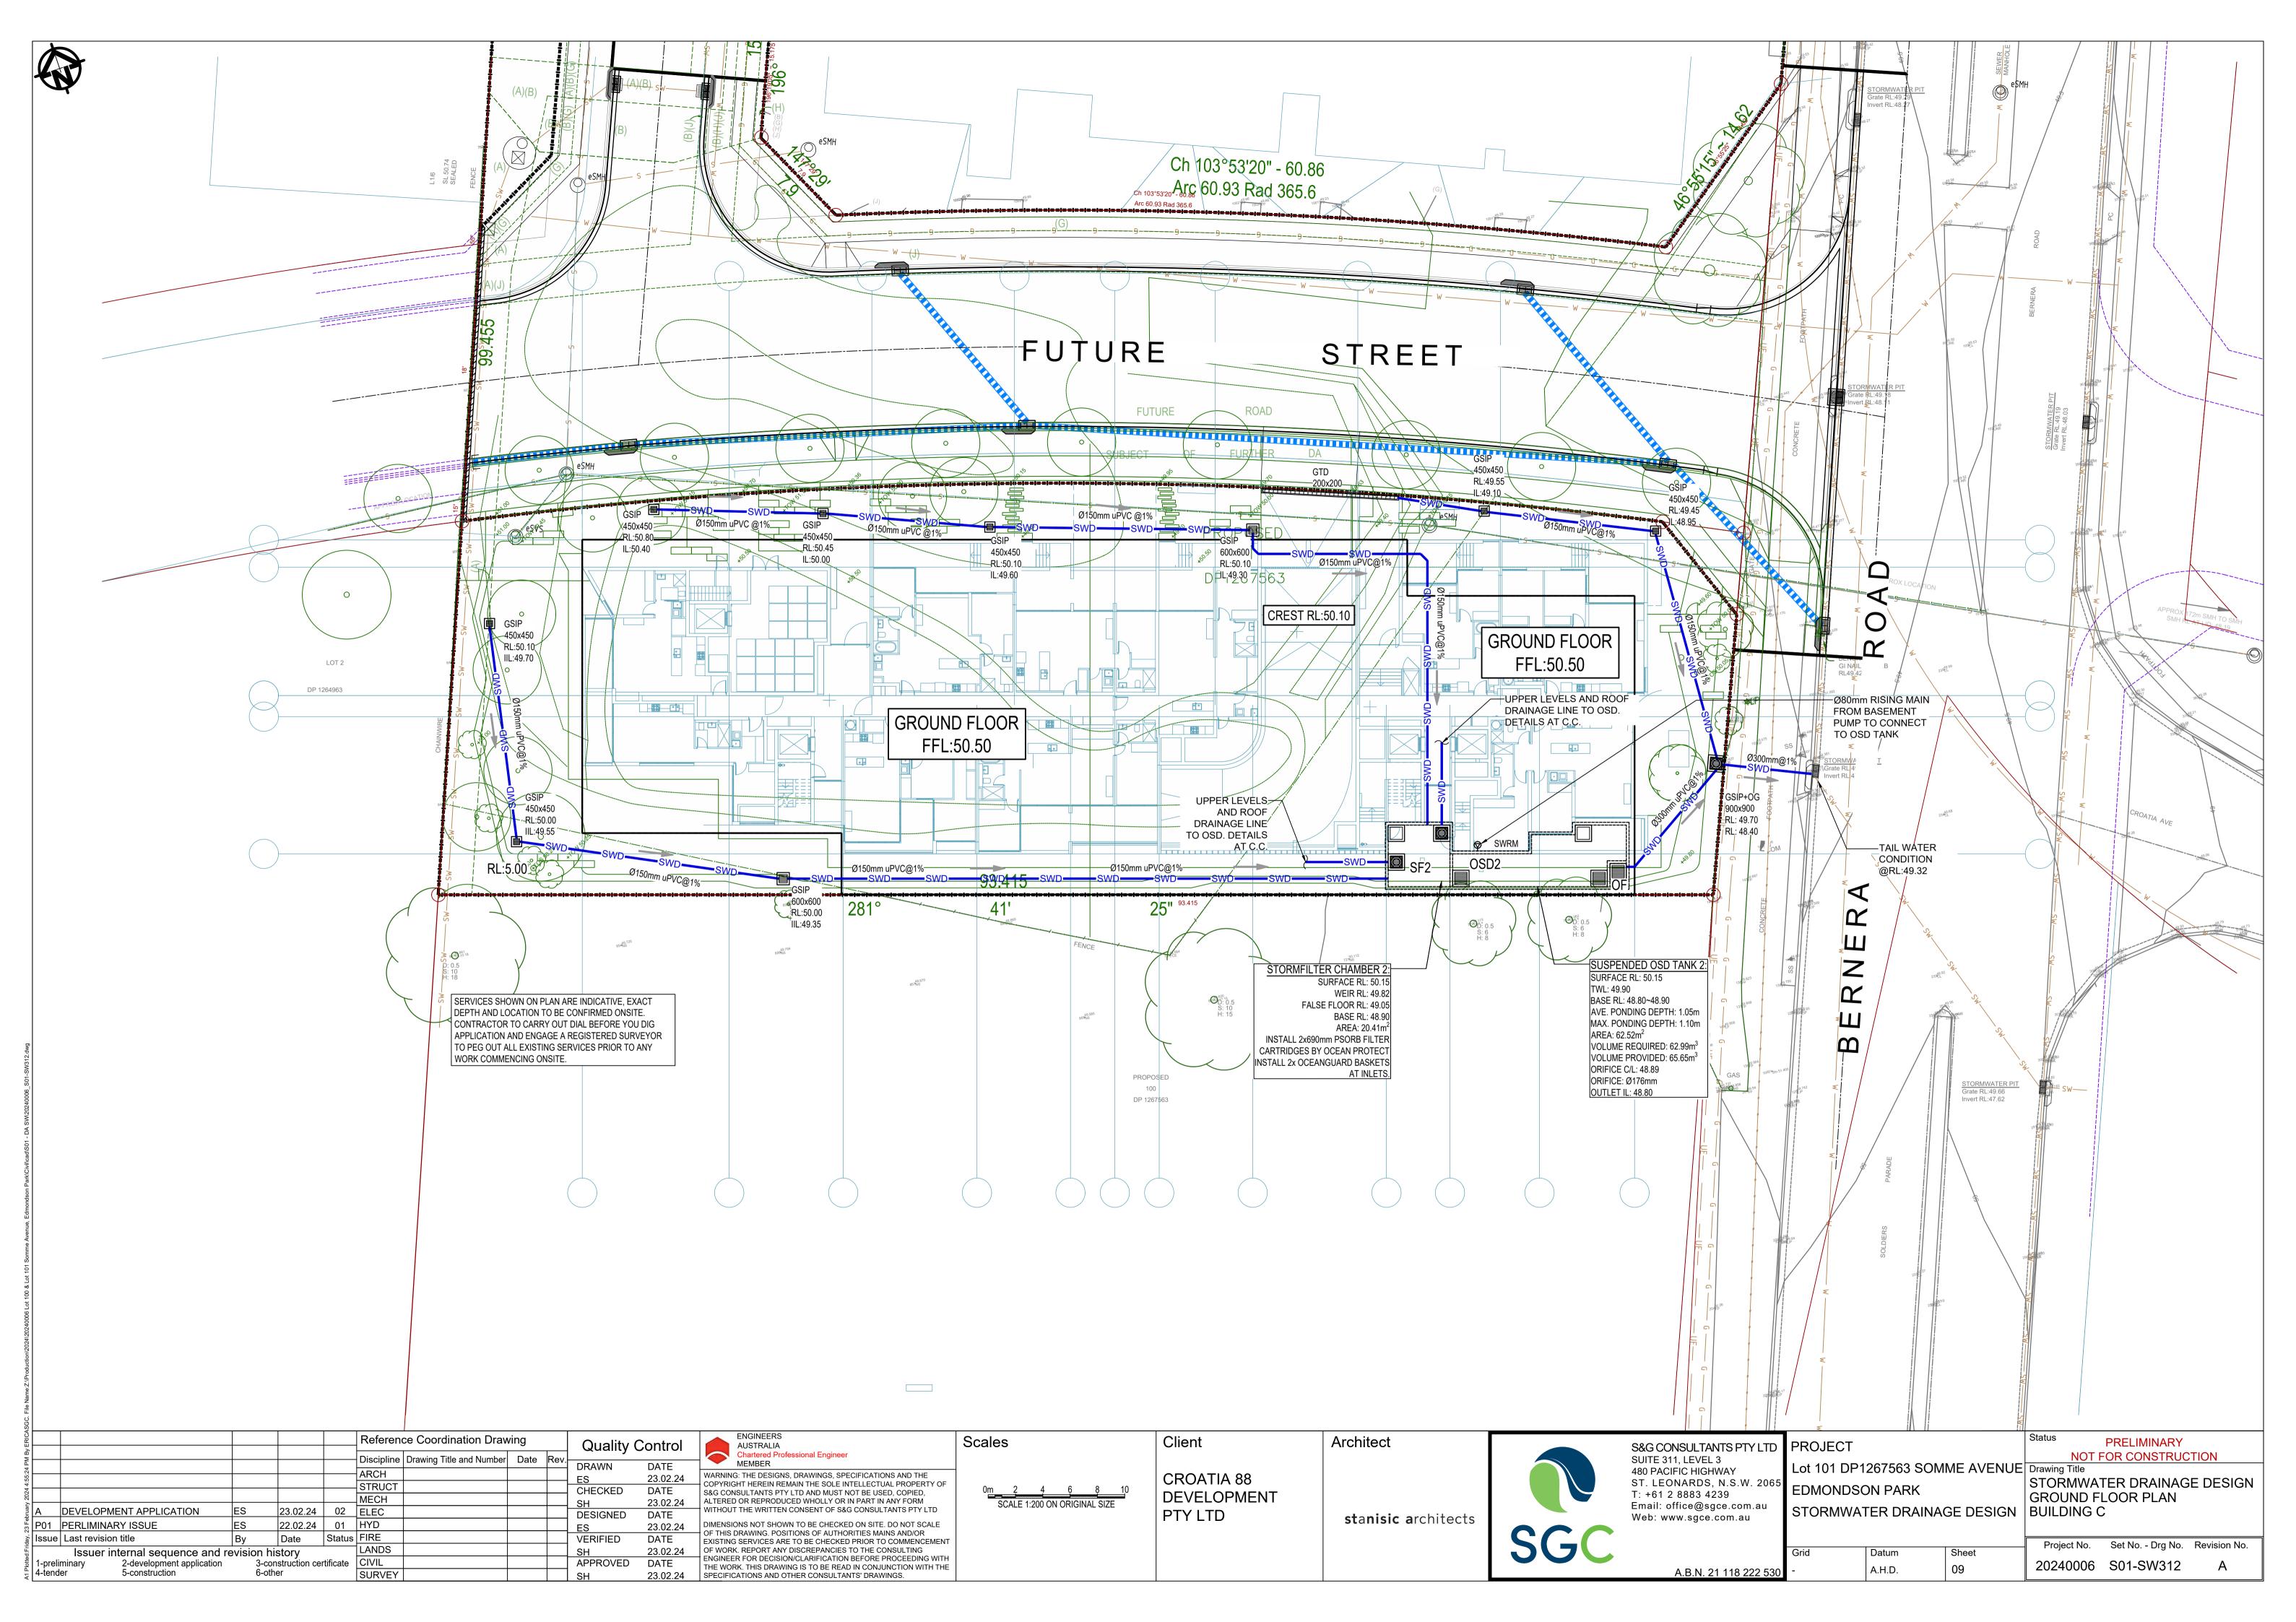

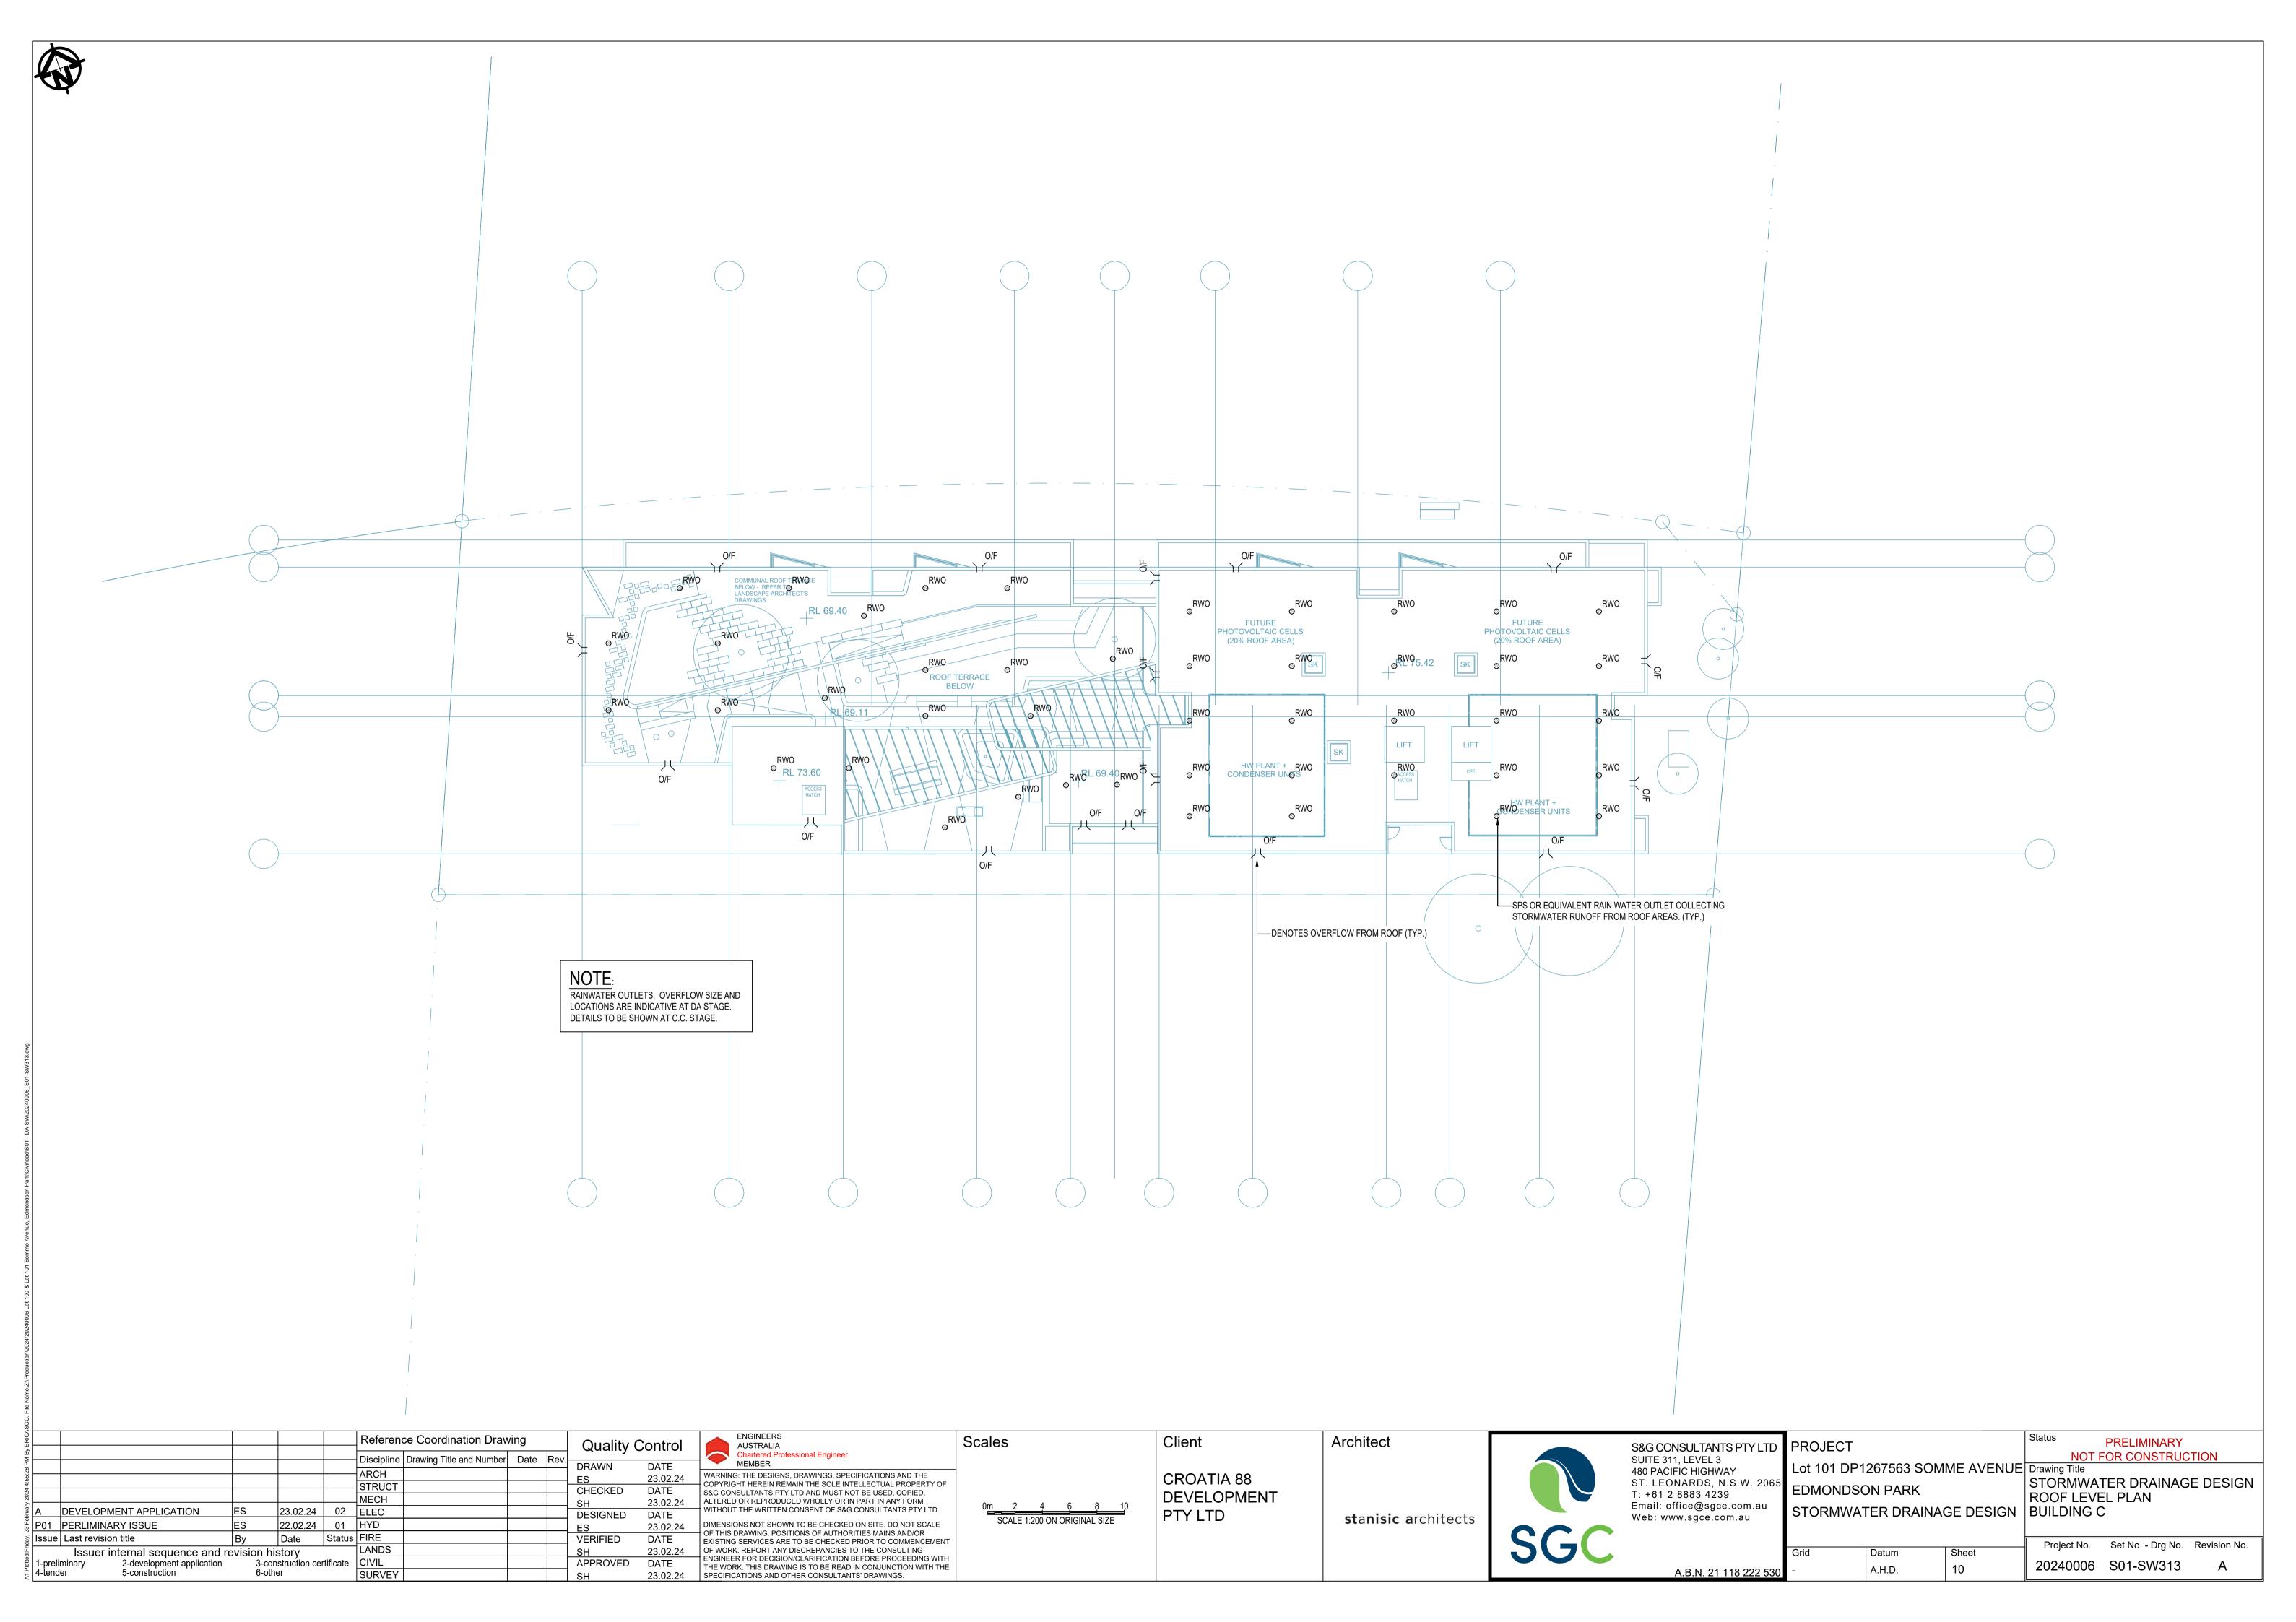


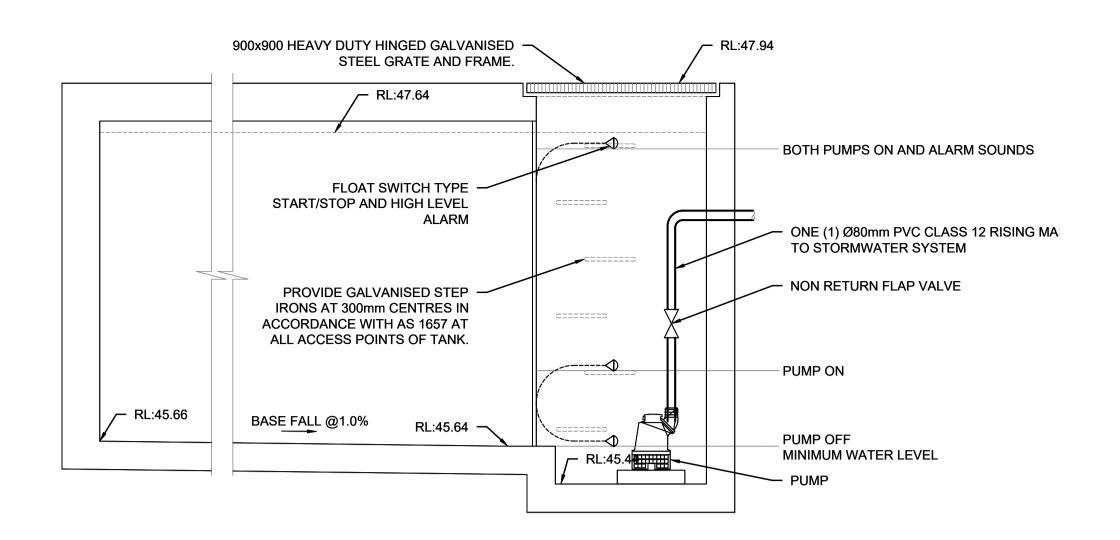



DETAIL: SUBSOIL PUMP-OUT PIT 01

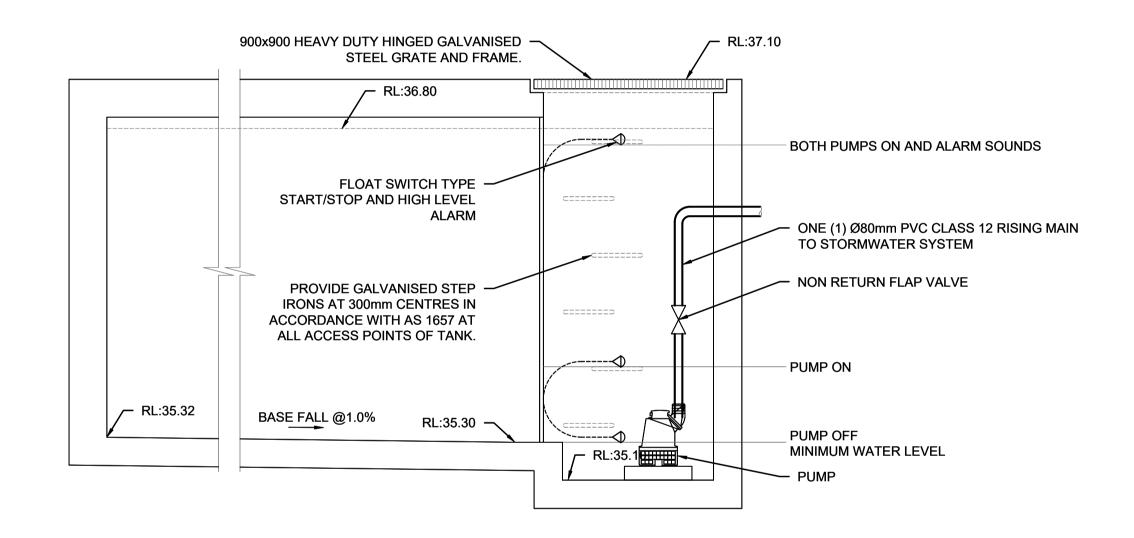



DETAIL: SUBSOIL PUMP-OUT PIT 02
SCALE 1:20

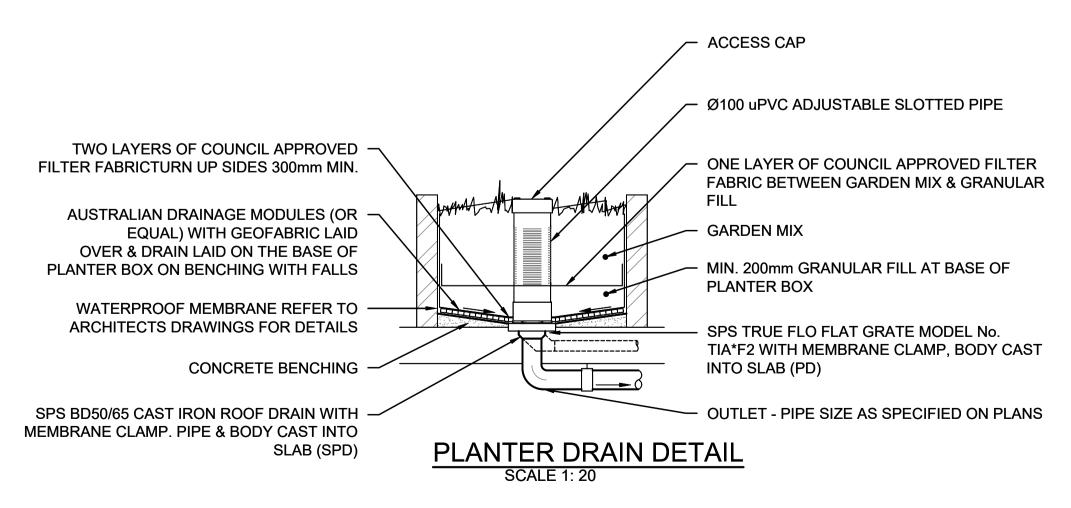


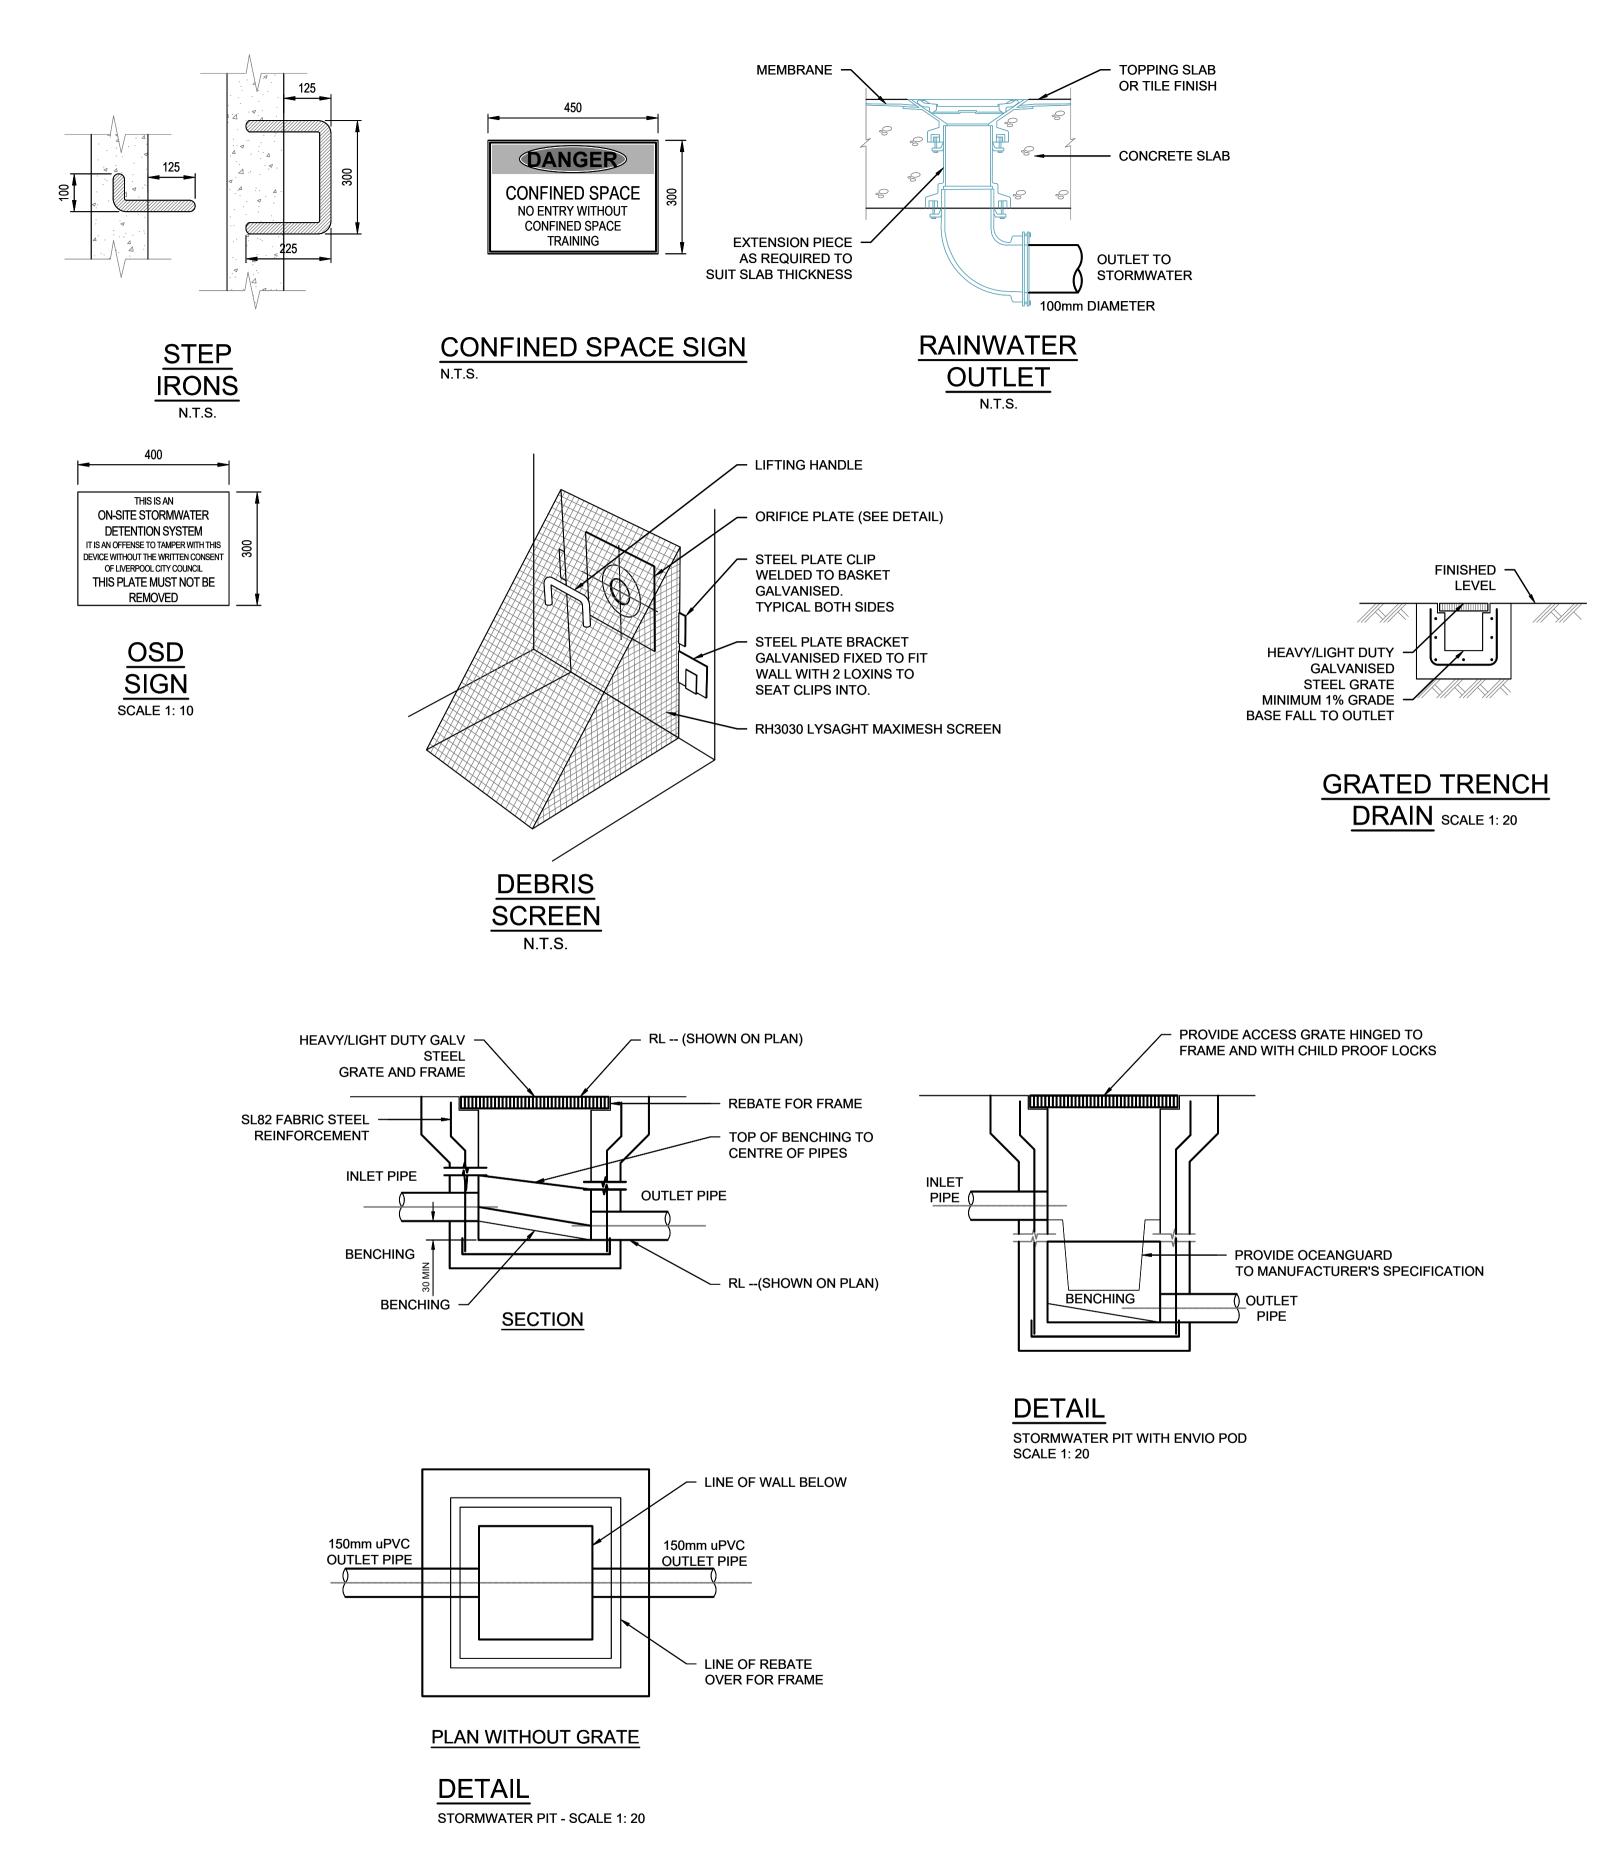

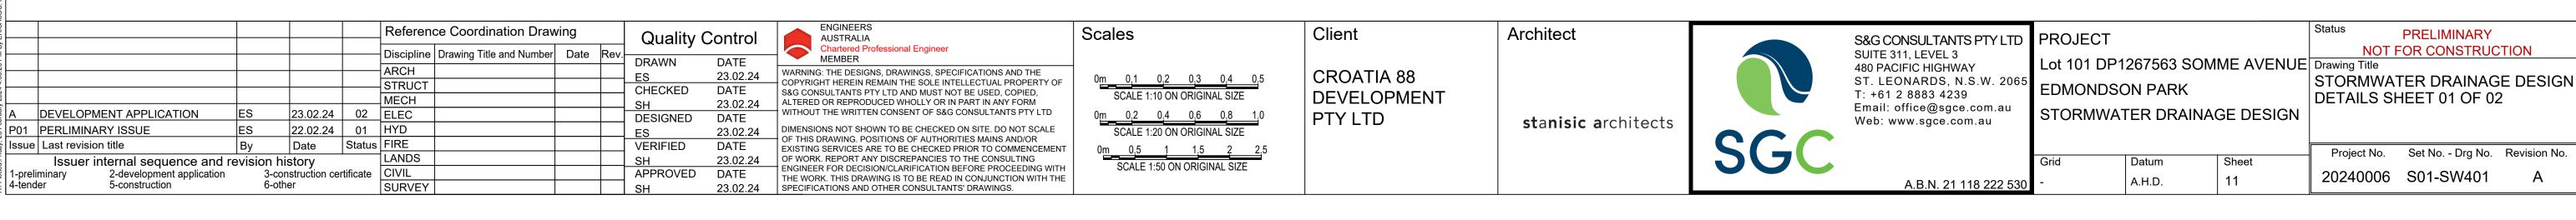

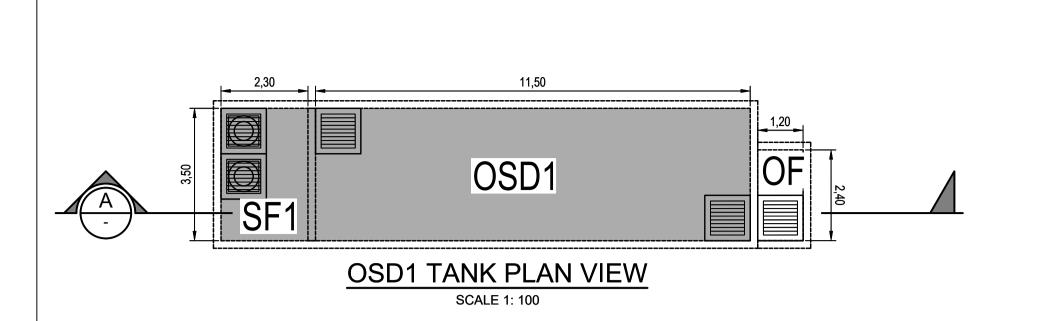

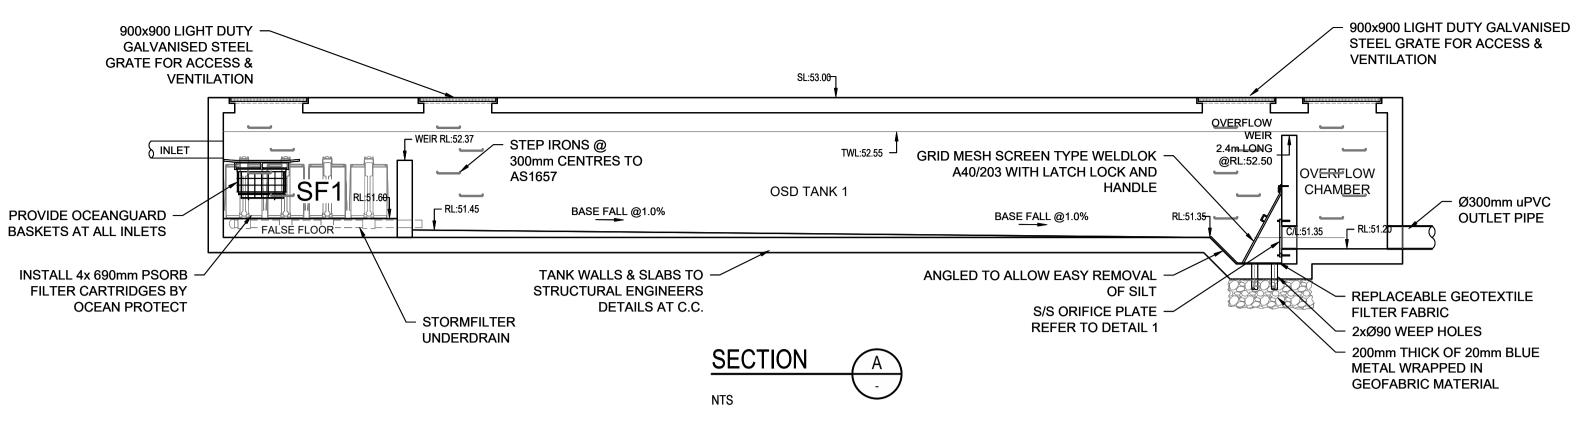


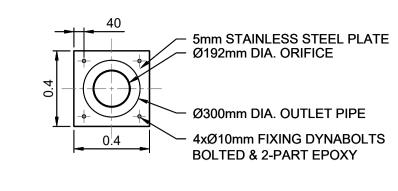


ORIFICE PLATE 01
SCALE 1:20

#### POST-DEVELOPMENT OSD 1 CALCULATIONS TABLE:


LOT AREA (m2)	PRE-DEV IMPERVIOUS (%)	POST-DEV IMPERVIOUS (%)	STORM (YR)	PRE-DEV FLOW (m3/s)	POST-DEV FLOW (m3/s)	PIPE OUTFLOW (m3/s)	WEIR OUTFLOW (m3/s)	BYPASS FLOW (m3/s)	TOTAL PSD (m3/s)	OSD VOLUME (m3
		5	0.070	0.112	0.055	N/A	0.015	0.070		
5000	5000 0	62.1	20	0.122	0.166	0.072	N/A	0.024	0.096	56.13
			100	0.173	0.220	0.083	0.050	0.034	0.167	

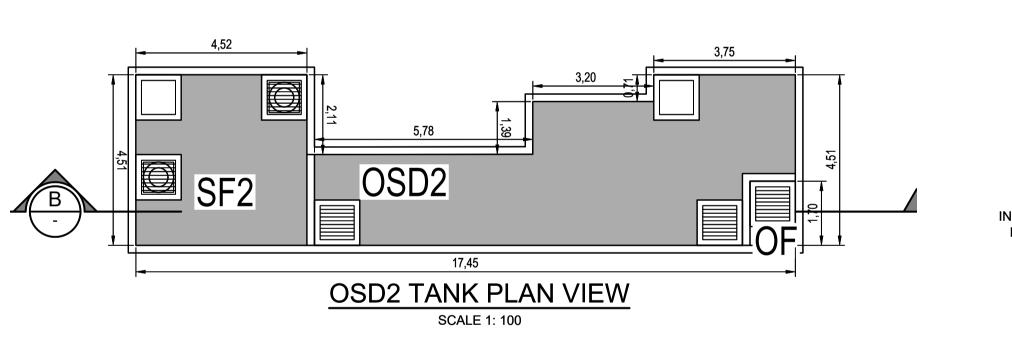

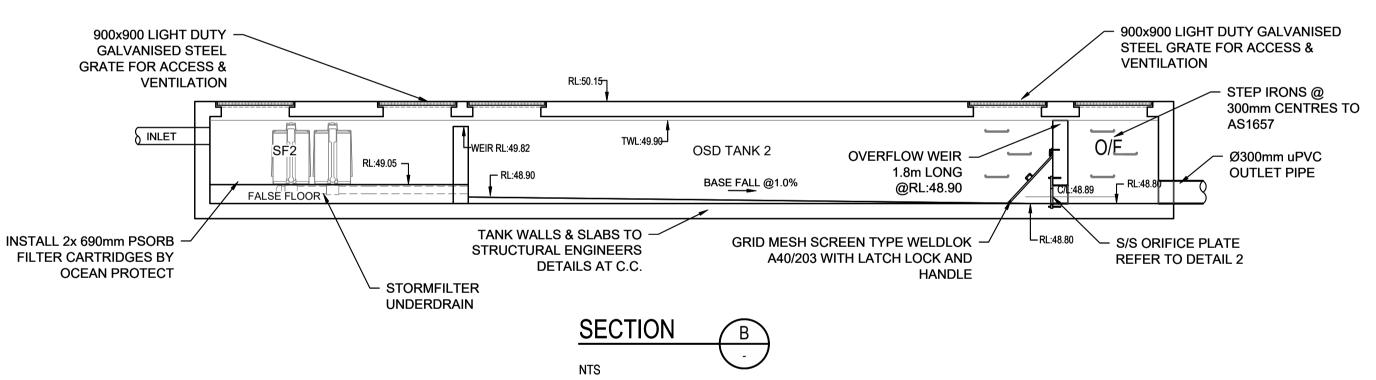

### POST-DEVELOPMENT OSD 2 CALCULATIONS TABLE:

LOT AREA (m2)	PRE-DEV IMPERVIOUS (%)	POST-DEV IMPERVIOUS (%)	STORM (YR)	PRE-DEV FLOW (m3/s)	POST-DEV FLOW (m3/s)	PIPE OUTFLOW (m3/s)	WEIR OUTFLOW (m3/s)	BYPASS FLOW (m3/s)	TOTAL PSD (m3/s)	OSD VOLUME (m3)
			5	0.038	0.064	0.031	N/A	0.007	0.038	
2724	0	76	20	0.066	0.094	0.041	N/A	0.012	0.053	62.99
			100	0.094	0.126	0.050	0.014	0.017	0.081	

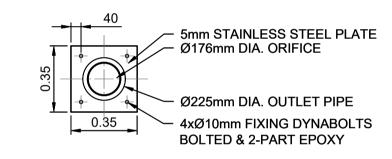

### ORIFICE PLATE 02 SCALE 1:20

#### **DESIGN NOTES:**

THE PROPOSAL IS FOR A RESIDENTIAL DEVELOPMENT LOCATED WITHIN LIVERPOOL COUNCIL.

TOTAL SITE AREA: 10111m<sup>2</sup>

THIS SITE IS NOT AFFECTED BY THE 1% AEP FLOODING.

ON-SITE DETENTION IS MANDATORY FOR THE DEVELOPMENT AS PER COUNCIL'S DCP

OSD HAS BEEN DESIGNED AS LIVERPOOL COUNCIL'S DCP - ON-SITET STORMWATER DETENTION STANDARD


OSD HAS BEEN DESIGNED USING DRAINS SOFTWARE TO LIMITE THE RATE OF STORMWATER RUNOFF FROM THE POST DEVELOPMENT SITE IS NOT EXCEED THE RATE OF RUNOFF FROM THE PRE-DEVELOPMENT SITE FOR THE RELEVANT STORM EVENTS, REFER TO DRAINS MODEL RESULTS

WSUD STRATEGY IS MANDATORY FOR THE DEVELOPMENT AS PER COUNCIL'S DCP-WATER CYCLE MANAGEMENT


POST DEVELOPMENT WATER QUALITY TARGETS:

TSS=80% TP=45% TN=45%

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77 PM By EF			Discipl	ine Drawing Title and Number Date Re	Quality  DRAWN	Control DATE	AUSTRALIA Chartered Professional Engineer MEMBER	Scales - 0m 0.1 0.2 0.3 0.4 0.5	Client	Architect		S&G CONSULTANTS PTY LTD SUITE 311, LEVEL 3 480 PACIFIC HIGHWAY	PROJECT Lot 101 DP1267563	SOMME AVENUE	PRELIMINARY  NOT FOR CONSTRUCTION  Drawing Title
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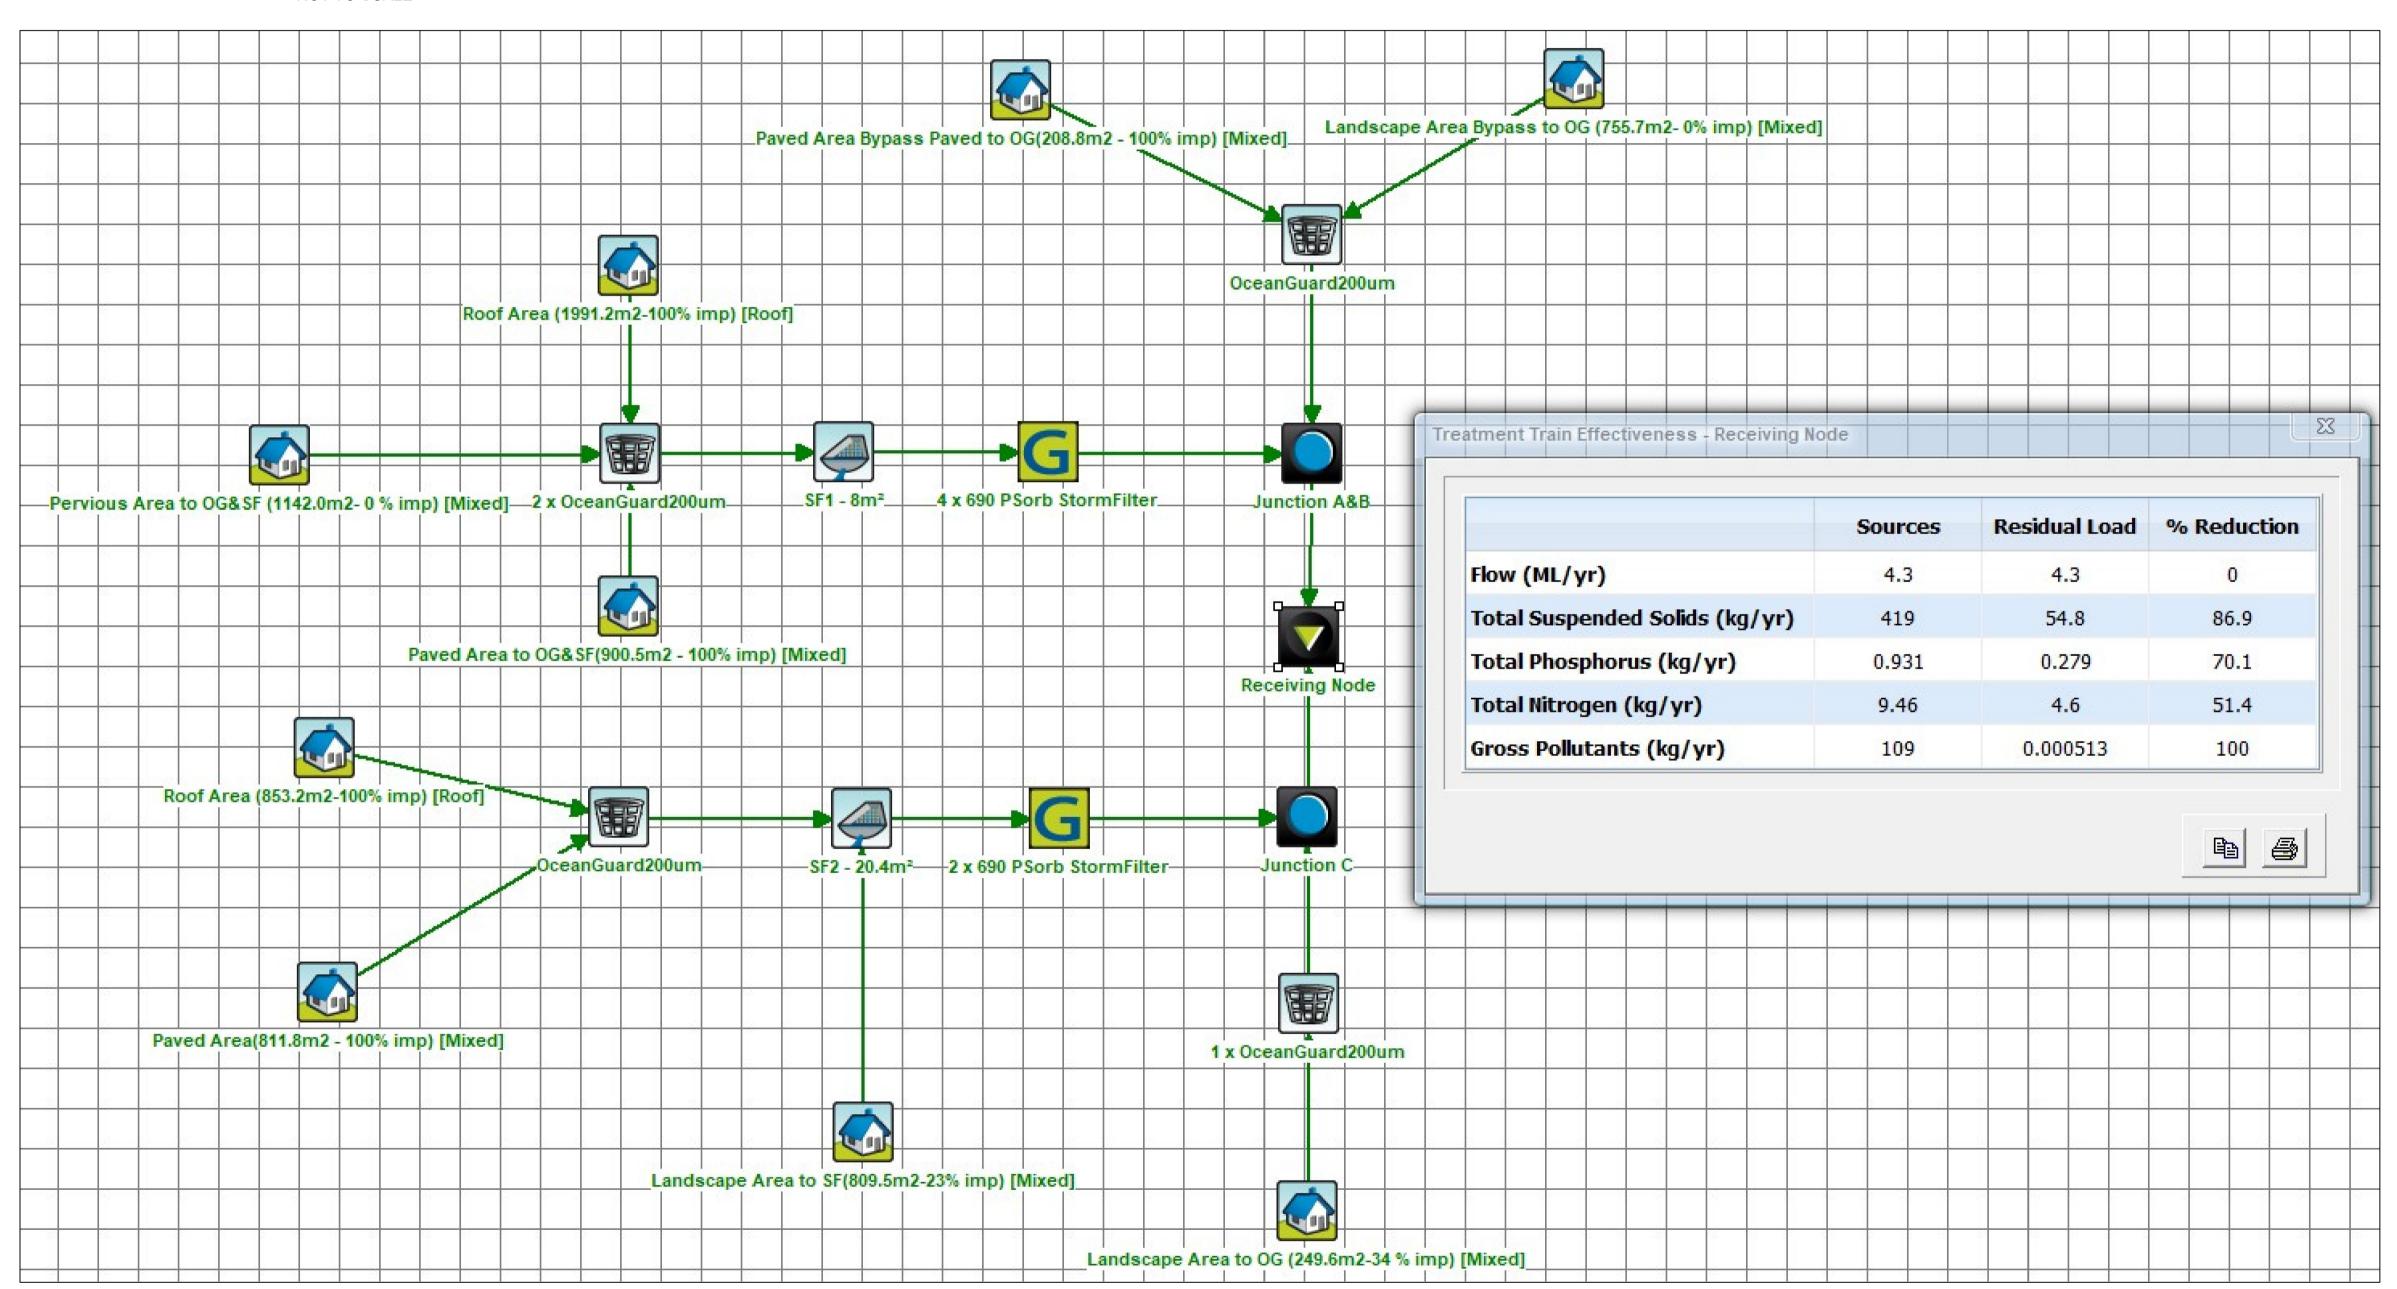


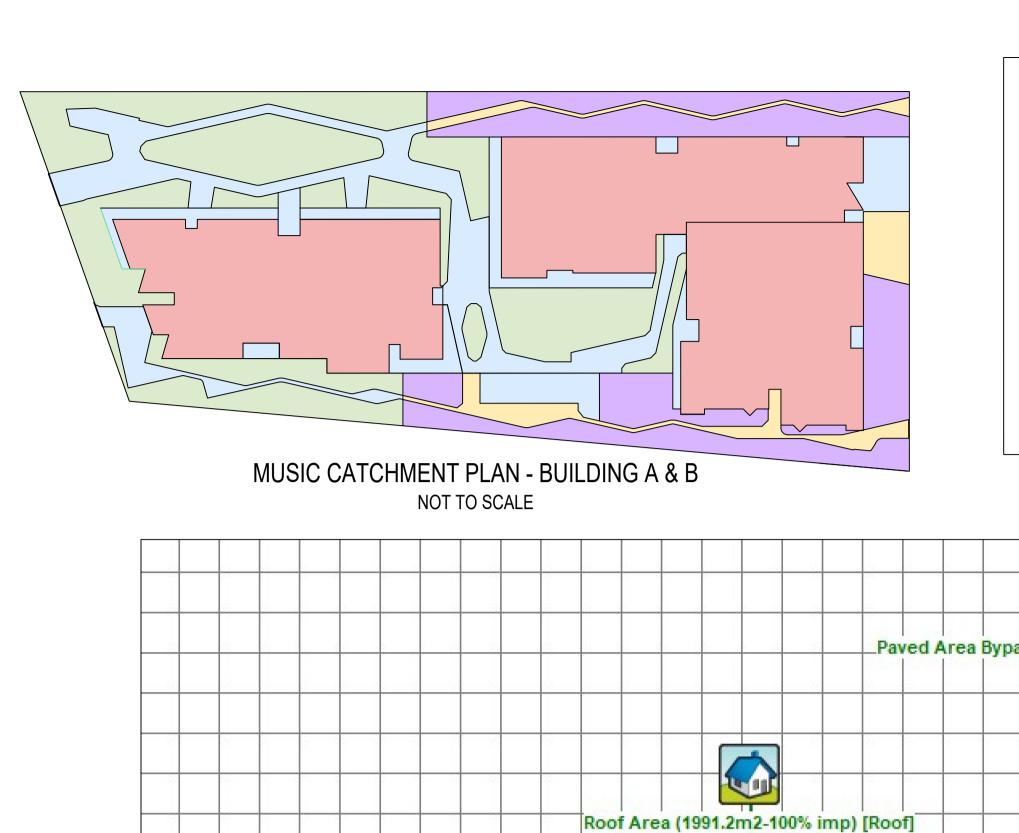



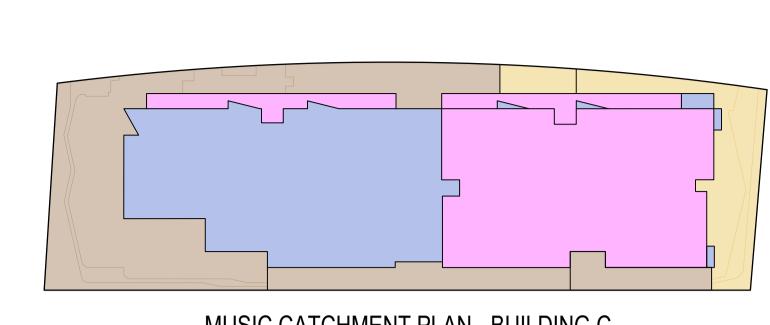


MUSIC CATCHMENT PLAN - BUILDING C
NOT TO SCALE





## MUSIC RESULTS


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1-preliminary 2-development application 3-construction certificate 4-tender 5-construction 6-other CIVIL  SURVEY	APPROVED DATE	ENGINEER FOR DECISION/CLARIFICATION BEFORE PROCEEDING WITH THE WORK. THIS DRAWING IS TO BE READ IN CONJUNCTION WITH THE SPECIFICATIONS AND OTHER CONSULTANTS' DRAWINGS.				A.B.N. 21 118 222 530	40	20240006 S01-SW501 A

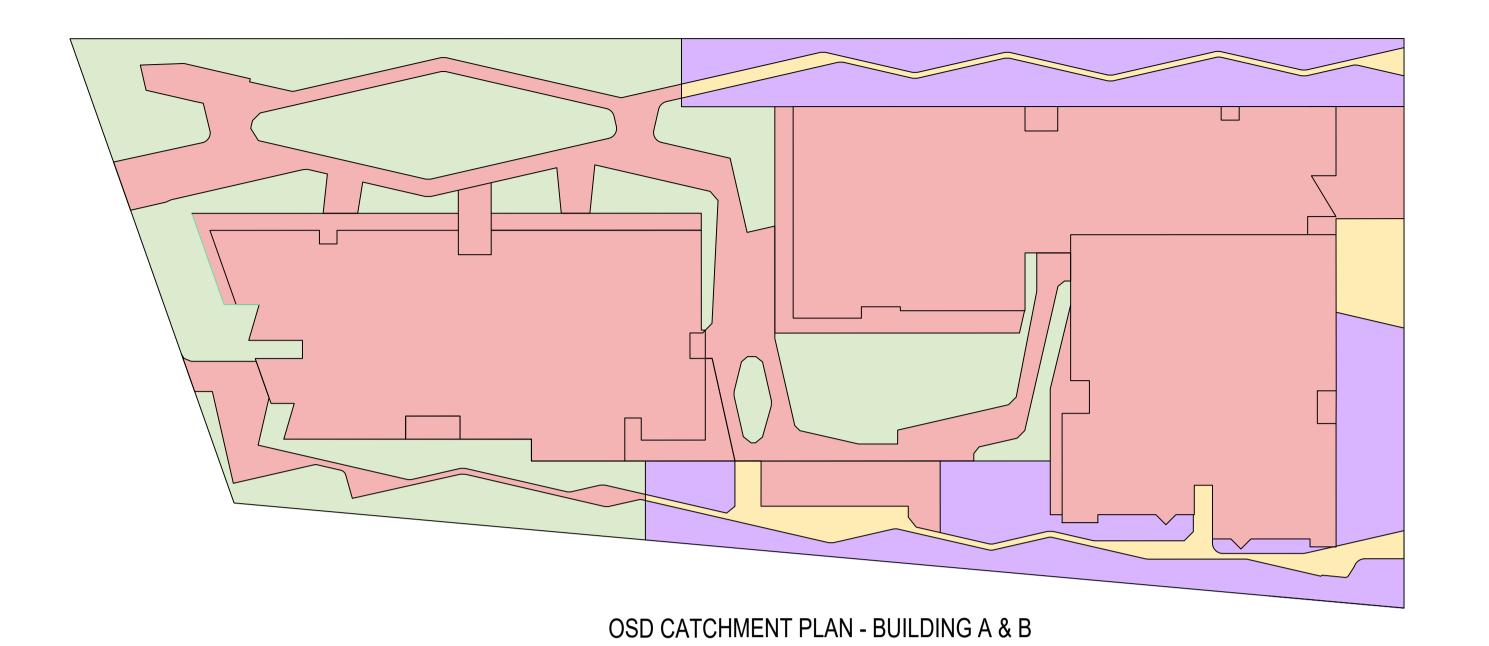

NOT TO SCALE

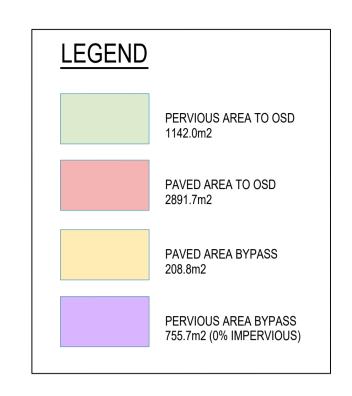

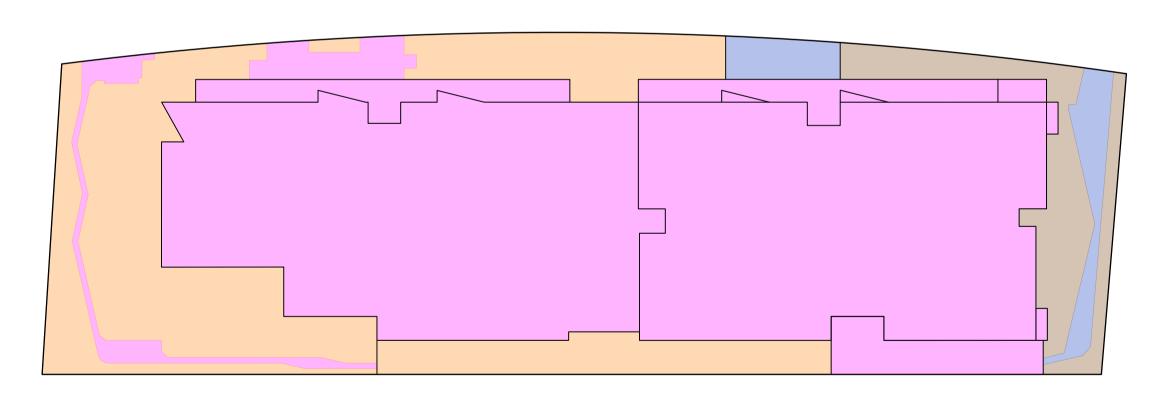

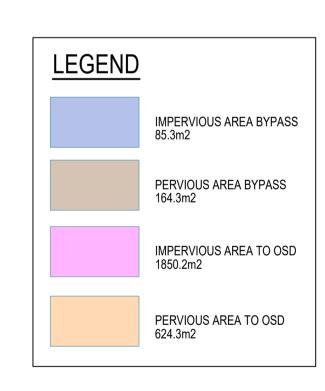

OSD CATCHMENT PLAN - BUILDING C
NOT TO SCALE

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₹ T-terider 5-construction	0-00161	SURVEY	SH	23.02.24	SPECIFICATIONS AND OTHER CONSULTANTS' DRAWINGS.					A.D.N. 21 110 222 330		